

Ohio Museum Complex HVAC Lin Hall, The Ridges – Ohio University Athens, Ohio

02/27/2024

ADDENDUM 02

Addendum to the drawings and specifications for: Ohio Museum Complex HVAC

This addendum supplements and amends the drawings and specifications and shall become part of the contract documents. The contractor shall acknowledge receipt of this addendum on the Bid Form and incorporate the information herein contained in the preparation of his/her proposal.

PRE-BID MEETING

- 1. Sign In Sheet: Attached
- 2. Pre-Bid Meeting Agenda: Attached

SPECIFICATIONS

- 1. Competitive Sealed Bid Documents HAPCAP Front End Article 15 Payment
 - a. Remove Article 15 and replace with the following:

Payment to the Contractor shall be made as follows: The Contractor may submit a Contractor Payment Request for Work performed based upon the Schedule of Values to the A/E each month or upon another interval approved by the Contracting Authority. When the rate of Work and amount involved is sufficient that it is considered appropriate by the Contracting Authority, the Contractor may submit Contractor Payment Requests twice a month.

The Owner's Representative shall certify on the pay request that he approved the completed work prior to the Owner making payment. Upon receipt of an approved invoice from the Contractor, the Owner shall submit a drawdown request to the Ohio Department of Development for CDBG funds to pay the Contractor. A turnaround time of 30 - 45 days is expected before said funds are forwarded to the Owner.

2. Solicitation

- a. Replace previous Solicitation with revised.
- b. Increase Alternate 1 estimate amount

DRAWINGS

1. Sheet D101 – General Notes

Add General note 11. CONTRACTOR TO ASSUME THAT LEAD PAINT IS PRESENT IN THE BUILDING AND PROVIDE CONTROLS DURING CORING OF EXISTING WALLS

- **2.** Sheet D104 Mechanical room finish revisions.
- 3. Sheet D105

Mechanical room finish revisions.

4. Sheet P5

Removed reference to pressed fittings on piping schedule.

5. Sheet H0

Added note to turn over refrigerant to OU if chiller alternate is accepted.

6. Sheet H2

Removed all fin tube radiation.

7. Sheet H3.1

Relocated AHU-5A and RAF-5A to reduce size of mechanical room. Relocated VFDs, Temperature Control Panel and Humidifier unit H-9 in this room. Added note to install full size drain pan under AHU units and coil piping connections.

- **8.** Sheet H3.2 Relocated piping connections to AHU-5A.
- **9.** Sheet H4.1

Relocated AHU-6A and RAF-6A to reduce size of mechanical room. Relocated VFDs, Temperature Control Panel and Humidifier unit H-9 in this room. Added note to install full size drain pan under AHU units and coil piping connections.

10. Sheet H4.2

Relocated piping connections to AHU-A.

- 11. Sheet H5 Removed fin tube radiation piping detail. Added detail 3/H-5 to clarify Heating Water System Pump replacement is base bid work.
- **12.** Sheet E3 Revisions for AHU.
- **13.** Sheet E4 Revisions for AHU.
- 14. Sheet E6

Panel revisions.

CONTRACTOR QUESTIONS

- Can solder be used for copper piping in lieu of "Silfos"? Response: If copper piping is used for chilled water and heating water system then Bridgit lead-free nickel-bearing alloy solder must be used. Copper piping larger than 2" diameter must have joints "tinned" prior to final soldering of joint.
- 2. If there are no ceilings in space can temperature control wiring be exposed? Response: Rooms/spaces north of main stairs will have future ceilings and wiring may be exposed in these locations. Rooms south of main stairs (310-318, 410-418) may not have future ceilings and ductwork and wiring will be painted flat black. Wiring should be concealed in conduit for these spaces to allow painting of conduits.

ATTACHED Revised Solicitation Sheets: D104, D105, P5, H0, H2, H3.1, H3.2, H4.1, H5, E3, E4, E6

END OF ADDENDUM 02



26 East Park Drive, Ste 101, Athens, Ohio 45701 33 N Grant Ave, Ste 150, Columbus, Ohio 43215

PRE BID AGENDA

Project:Ohio Museum Complex HVAC – Lin HallMeeting Date:02/22/24Meeting Title:Pre Bid Meeting

1. Project Overview

- a) Overview of Project Scope
 - HVAC work on B, 2, 3 and 4 including air handler units, piping, ductwork, controls
 - Electrical updates to support new HVAC equipment
 - Exterior storm water controls
 - Exterior building envelope improvements
 - Interior building envelope improvements
- b) Alternates
 - Alternate 01 New exterior pad mounted chiller
 - Alternate 02 New Replacement Humidifiers
- c) Contract Arrangement GC
- d) Completion Time: 300 Days.
- e) No ACM identified
- 2. Addendum 01
 - a) Bid date extension issued 2/16/24
- 3. Project Restrictions
 - a) Building will be partially occupied during project.
 - b) Maintaining building conditioning for B, 1 and 2 throughout is a requirement
 - c) Site Utilization and Protection / Access to Site. Contractor to have full access
 - d) Job Storage/Staging: As agreed to by OU
 - e) Parking
 - f) Work Restrictions No restrictions on hours of work or work days
 - g) Work Restrictions Dust and Vibration
- 4. Temporary Facilities
 - a) Utility Usage Water, Sewer, Electric
- 5. Utility and Service Interruptions Sequencing
 - a) Protection of existing utilities to retain continuity and services
- 6. Bid Questions Deadline: 02/29/2024 by 2:00 pm
- 7. Bids Due 03/05/2024 by 2:00 pm.
- 8. Questions Additional Items



26 East Park Drive, Ste 101, Athens, Ohio 45701 33 N Grant Ave, Ste 150, Columbus, Ohio 43215

MEETING SIGN IN SHEET

Company BDT	Email
Phone/ Cell	Fax
Company	Email
-PRATER	
Phone/ Cell	Fax
	-
	Email
MAPCAP	
Phone/ Cell	Fax
Company	Email
A.J. STOCKMEISTERING	Rhomson @ STOCK MEISTER, CO
Phone/ Cell	Fax
740-577-6684	
Company KAL Ele	Email dikl @kalebedrit.ca
Phone/ Cell 740 -	Fax
541-4547	
	Phone/ Cell Company MAPCAP Phone/ Cell Company A.J. STOCK MEISTER INC Phone/ Cell 74-8-577-8684 Company KAL FLC Phone/ Cell 740-



26 East Park Drive, Ste 101, Athens, Ohio 45701 33 N Grant Ave, Ste 150, Columbus, Ohio 43215

Name	Company	Email
Eric Male	BCI	emale@bcicontrols.co
Address	Phone/ Cell	Fax
	614-306-0727	
Name Kyan Holbrock	Company	Email <u> rholbrooke</u> buicontrols. Co Fax
Address	Phone/ Cell	Fax
	614-506-6357	
Name	Company	Email
Address	Phone/ Cell	Fax
Name	Company	Email
Name	Company	Lindi
Address	Phone/ Cell	Fax
Name	Company	Email
Address	Phone/ Cell	Fax

INVITATION TO BIDDERS

Sealed Bids will be received by Athens County Commissioners, at the Commissioner's office,15 South Court Street, Athens, Ohio 45701 until **March 5, 2024, at 2:00 p.m.** local time, for the following project:

Ohio Museum Complex HVAC Improvements Lin Hall, Ohio University Athens, Ohio 45701

Sealed Bids will be received for a general contract for all material, labor and services as described in the Drawings and Specifications. Bids will be opened publicly at a date and time determine by the owner. All bids must be accompanied by a bid guaranty as noted in the project specifications.

A pre-bid meeting is scheduled for 2/22/2024 at 10:00am at Lin Hall. Meet at the main building entrance. All bidders are encouraged to attend this opportunity to inspect the area of work.

Drawings and Specifications prepared by:

BDT Architects and Interior Designers (BDTAID, Inc.) 26 E. Park Drive, Suite 101 Athens, Ohio 45701 Telephone: 740.592.2420


The project is for building renovations to Lin Hall at The Ridges including Abatement, General Trades, HVAC, Plumbing, Electric, Fire Alarm, Fire Sprinkler and Site Work.


Estimate of Probable Cost for total project is:	\$1	,700,000.00
Estimate of Probable Cost for Alternate H1 is:	\$	210,000.00
Estimate of Probable Cost for Alternate H2 is:	\$	62,000.00

Bidders may obtain hard copies of complete sets of the Bidding Documents from the Architect for a nonrefundable charge of \$150.00 per set. An electronic set of the Bidding Documents can be emailed to bidders at no charge.

END OF INVITATION TO BIDDERS

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ROOF

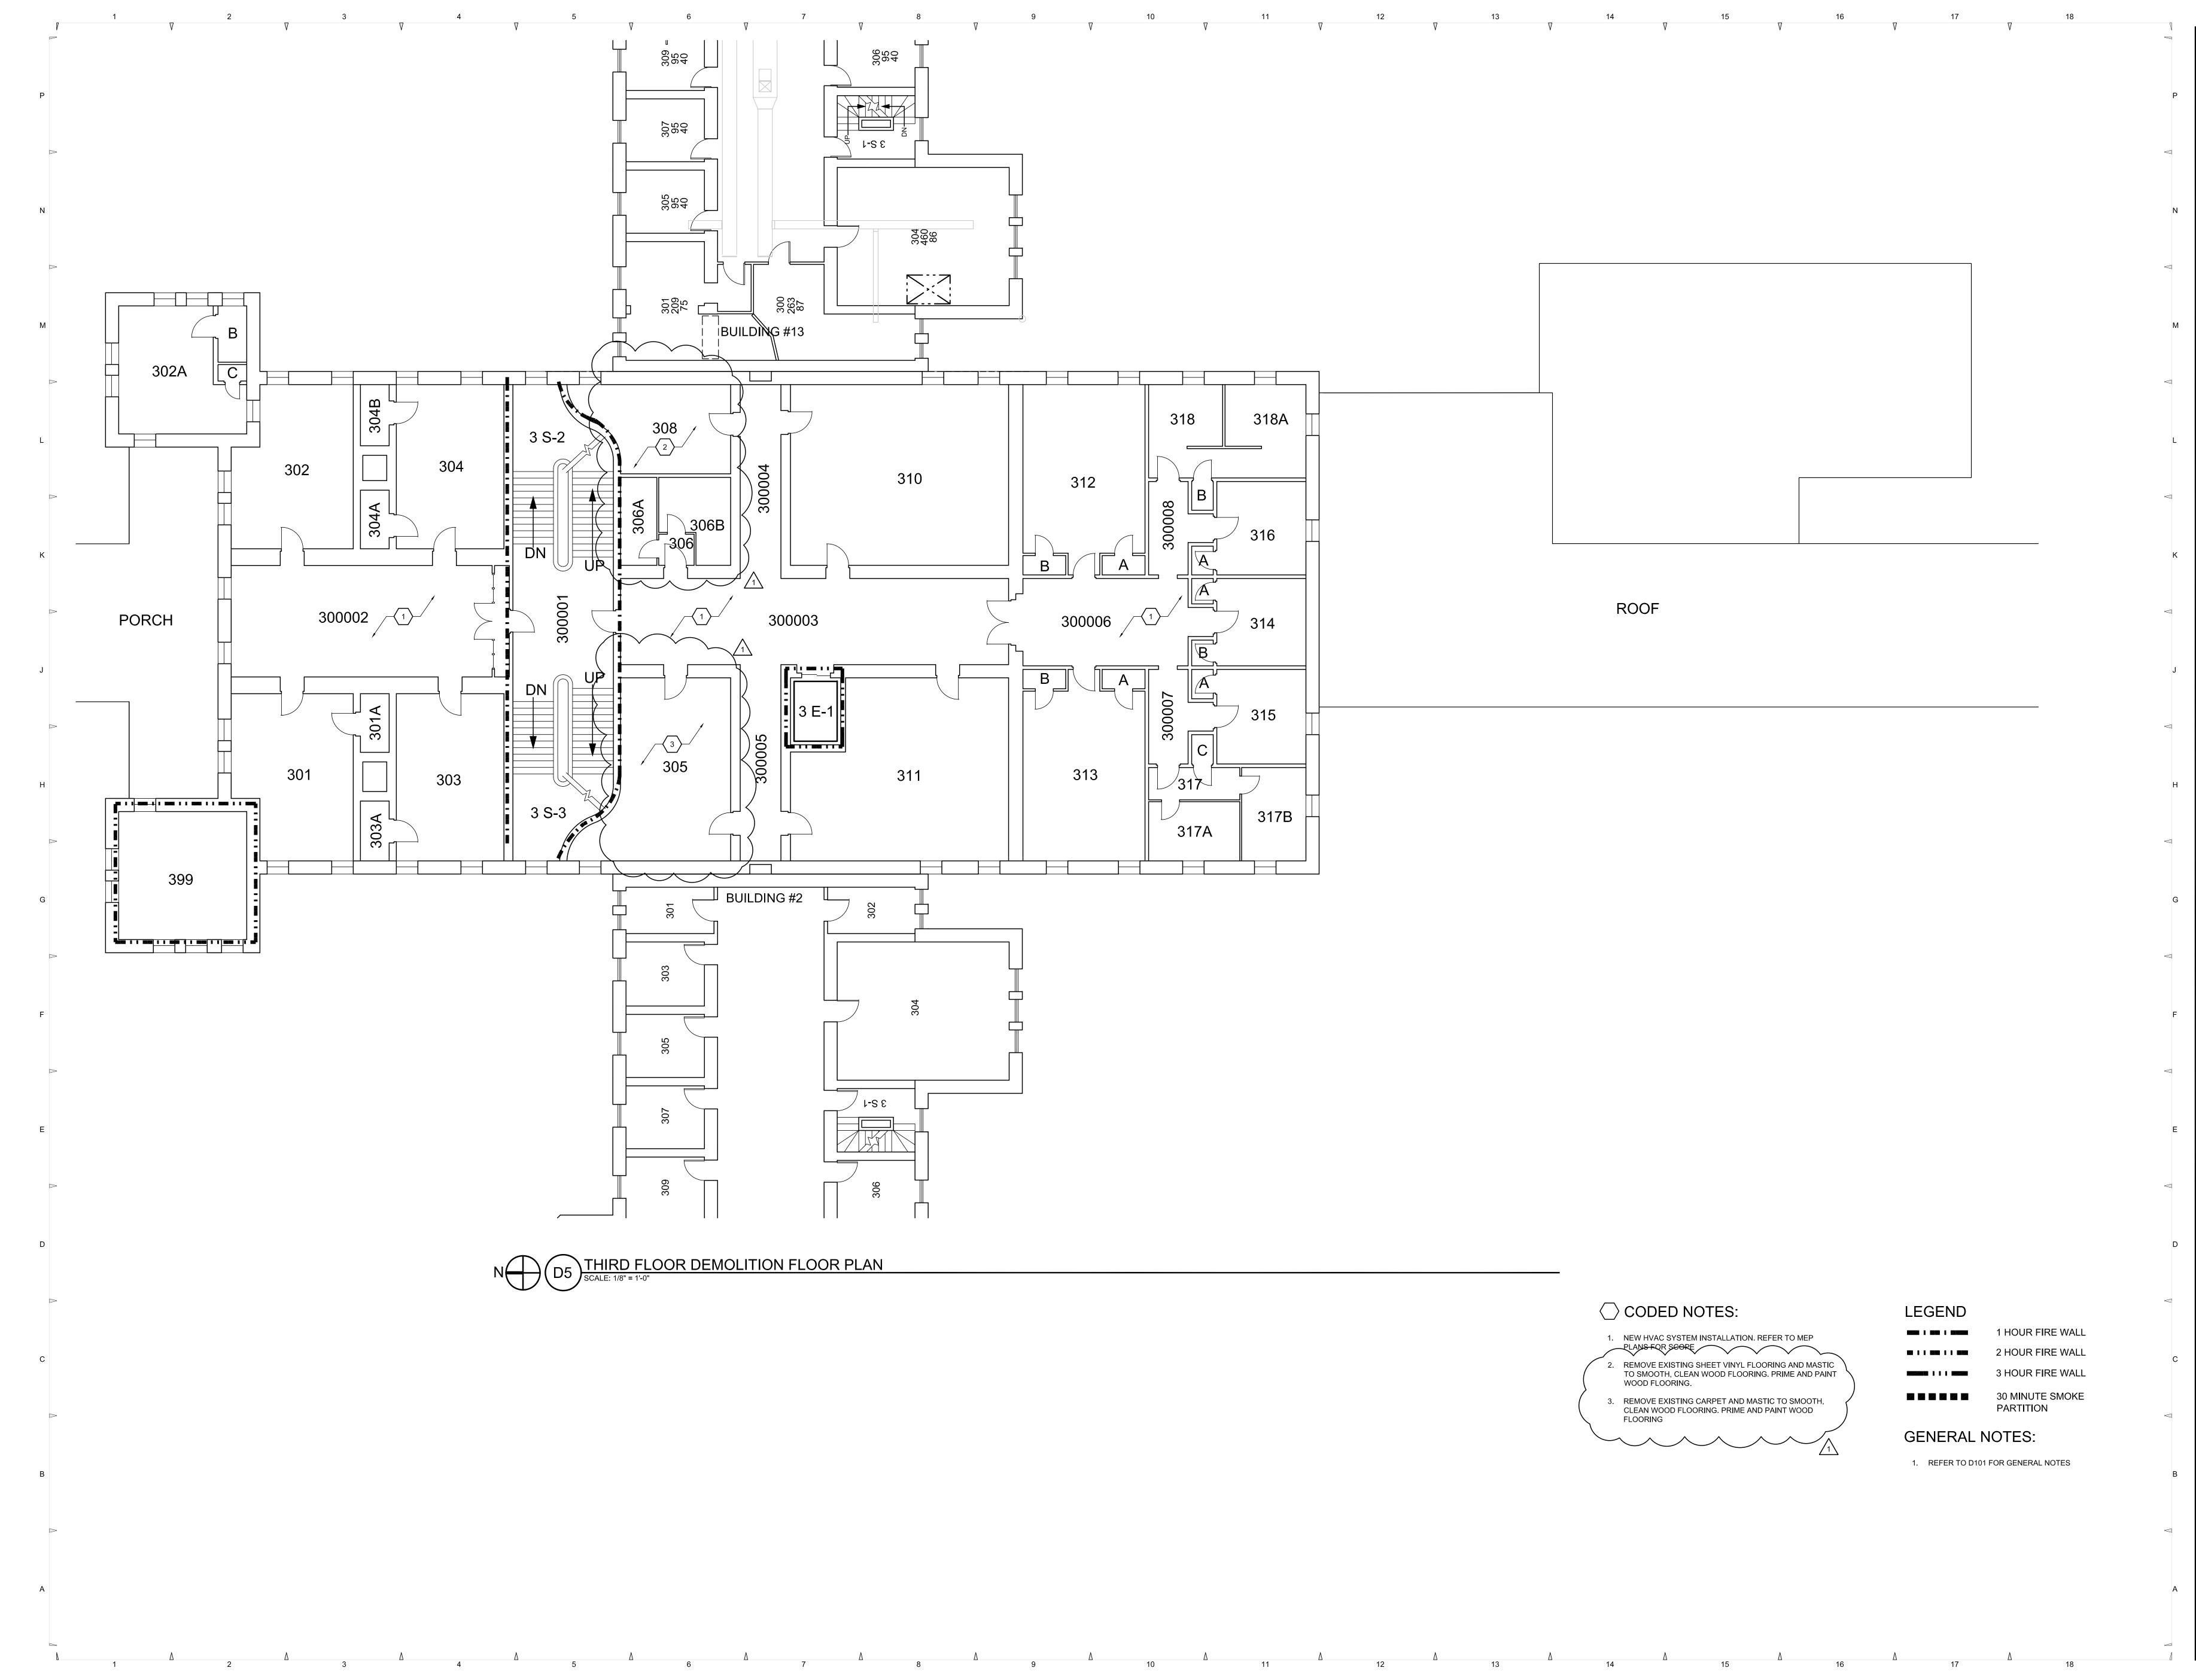

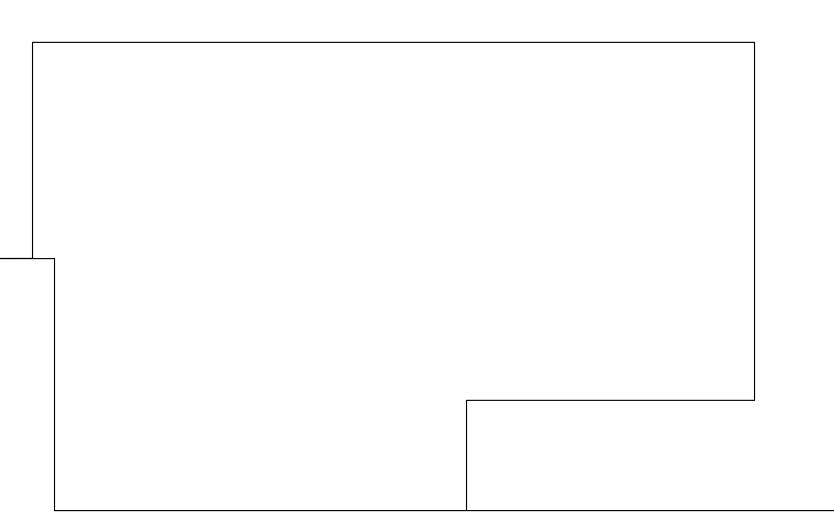_PLANS FOR SCORE REMOVE EXISTING SHEET VINYL FLOORING AND MASTIC


TO SMOOTH, CLEAN WOOD FLOORING. PRIME AND PAINT WOOD FLOORING.


3. REMOVE EXISTING CARPET AND MASTIC TO SMOOTH, CLEAN WOOD FLOORING. PRIME AND PAINT WOOD FLOORING

LEGEND

GENERAL NOTES:

16	17	V	18	V	
				P	BDTAID, Inc. 26 E. Park Drive, Athens, Ohio 45701 OFFICE 740-592-2420 ONLINE www.bdtaid.com EMAIL office@bdtaid.com
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				D	ISSUE DATES NO. DATE DESCRIPTION 01/09/24 BID SET 1 02/26/24 ADDENDUM 02 1 I I I I I I I I I I I
		1 HOUR FIRE V 2 HOUR FIRE V 3 HOUR FIRE V 30 MINUTE SM PARTITION	VALL VALL	с	PROJECT TITLE OHIO MUSEUM COMPLEX OU LIN HALL HVAC 100 RIDGES CIR.
	GENERAL 1. REFER TO D1	NOTES: 01 FOR GENERAL NOTE		B	PROJECT NUMBER 23002 DATE DRAWN
				A	SHEET TITLE THIRD FLOOR PLAN SHEET D104
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\bigcirc CODED NOTES:

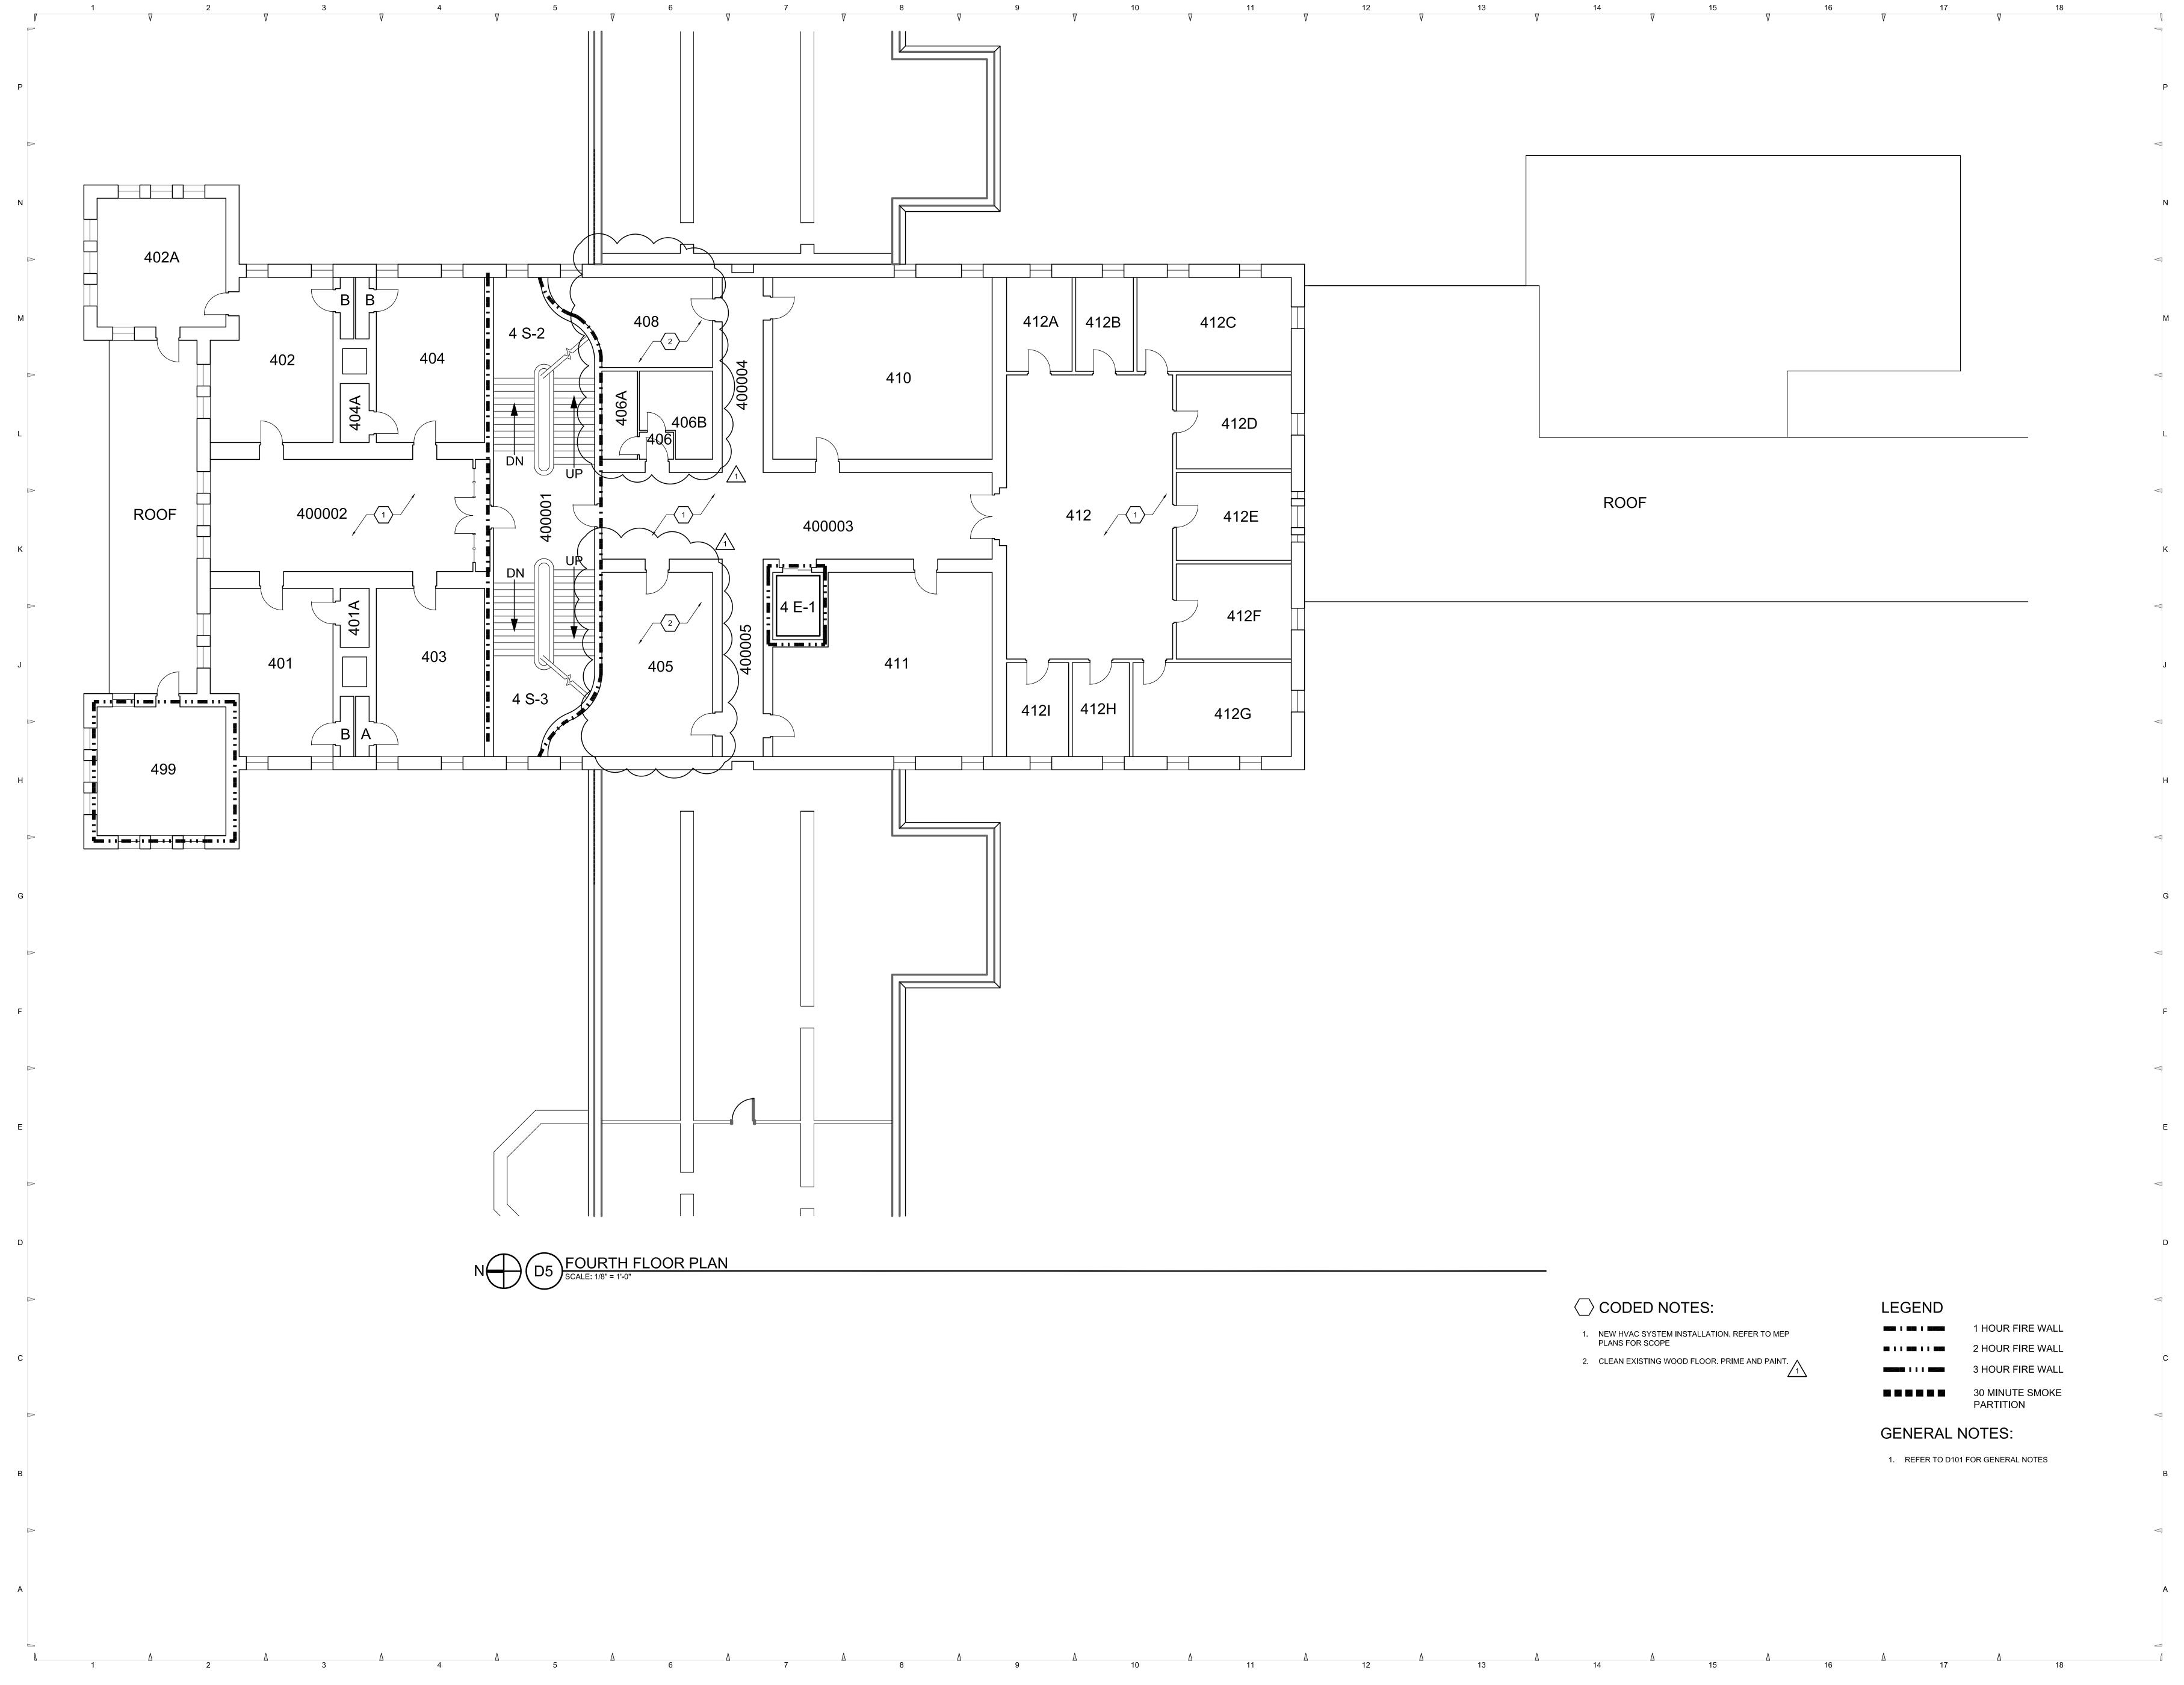1. NEW HVAC SYSTEM INSTALLATION. REFER TO MEP PLANS FOR SCOPE

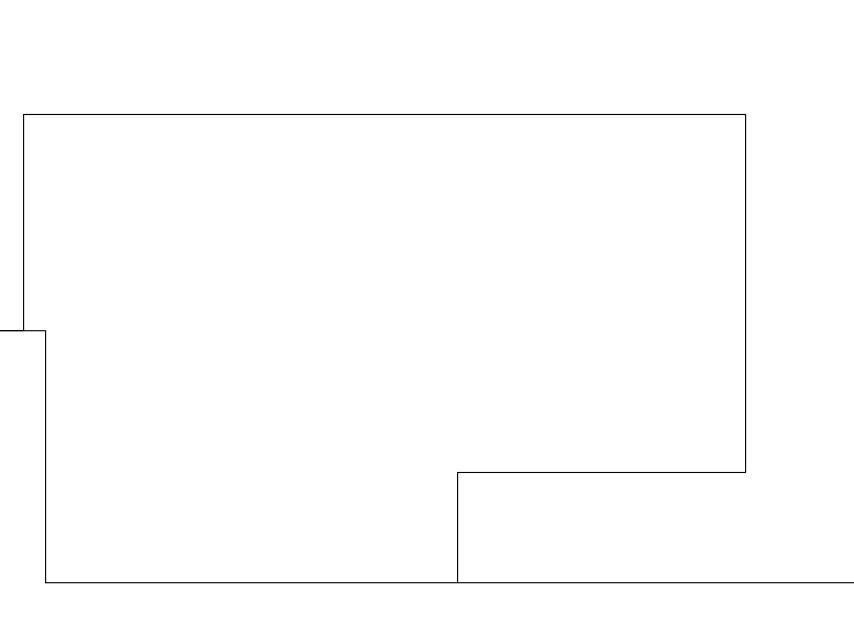
2. CLEAN EXISTING WOOD FLOOR. PRIME AND PAINT.

LEGEND

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GENERAL NOTES:

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			Р	bdt ARCHITECTS & DESIGNERS
				BDTAID, Inc. 26 E. Park Drive, Athens, Ohio 45701 OFFICE 740-592-2420
			\bigtriangledown	ONLINE www.bdtaid.com EMAIL office@bdtaid.com
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				PROJECT NUMBER 23002 DATE DRAWN
				SHEET TITLE FOURTH FLOOR PLAN
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				SHEET N 105
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17				

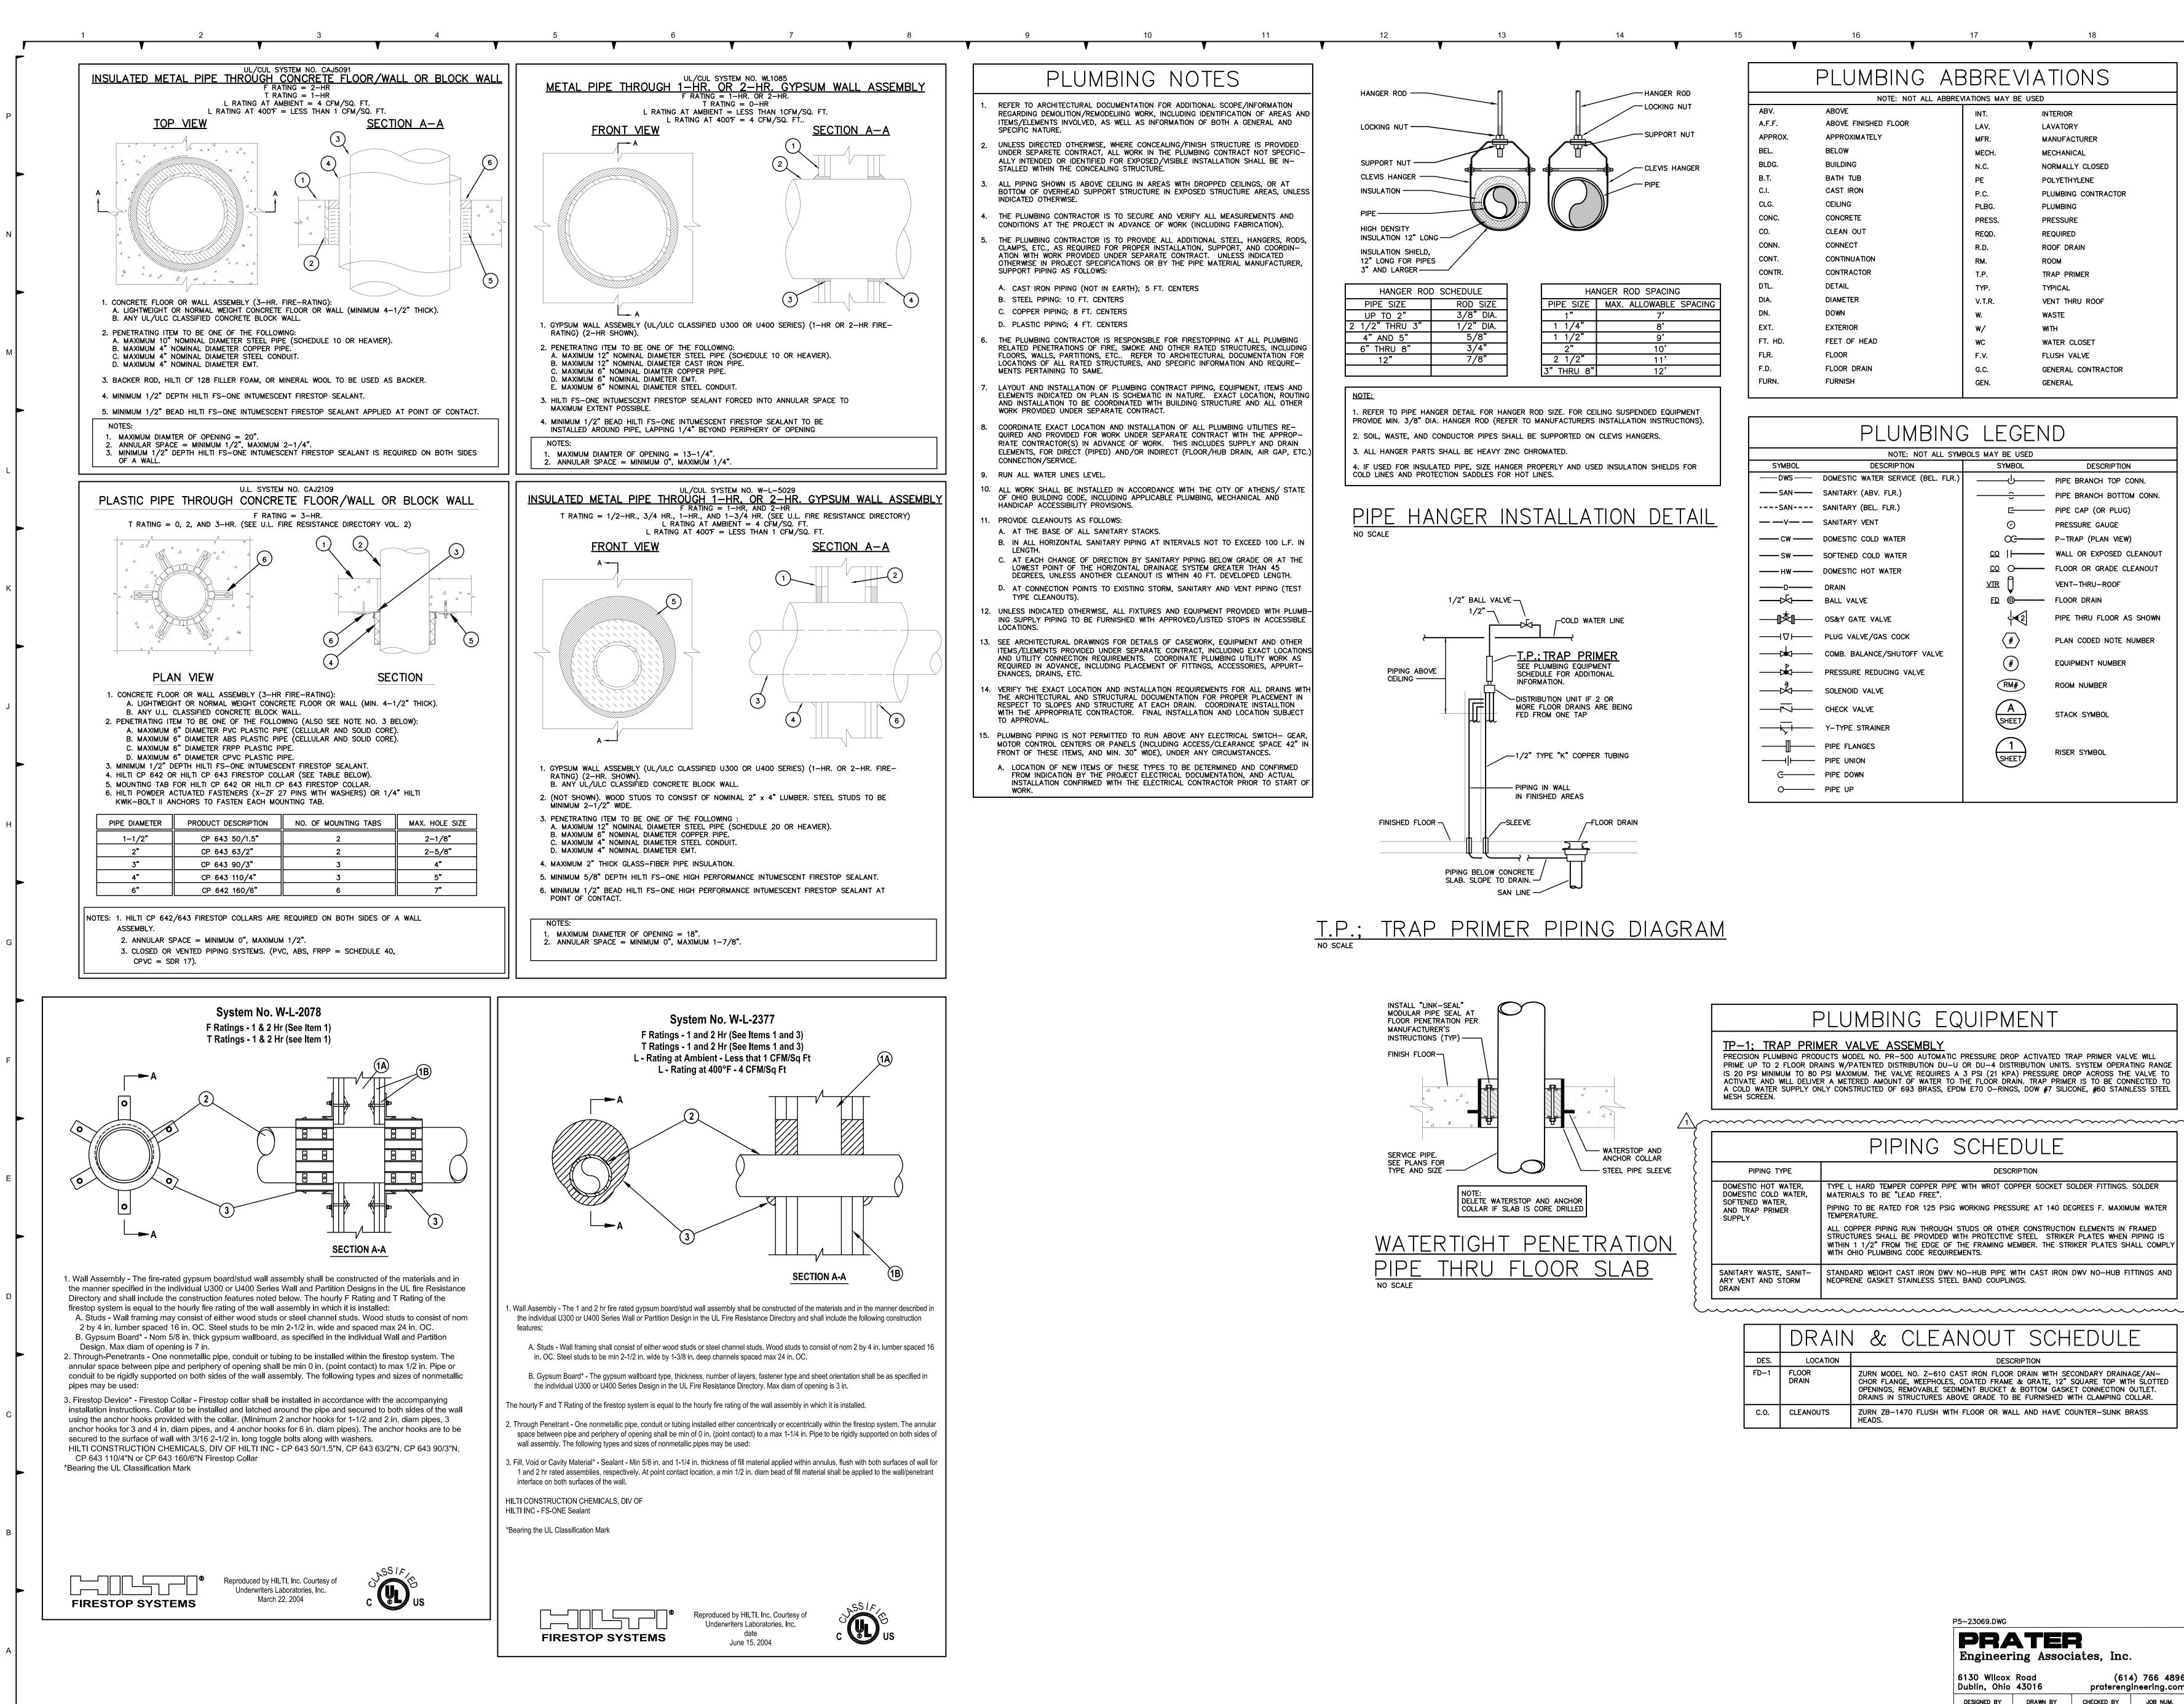

νP	PRIMER	PIPING	DIAGRAM

	FLOWDINC	J LLULIN	D
	NOTE: NOT ALL SYM		
SYMBOL	DESCRIPTION	SYMBOL	DESCRIPTION
—— DWS ——	DOMESTIC WATER SERVICE (BEL. FLR.)	ტ	PIPE BRANCH TOP CONN.
	SANITARY (ABV. FLR.)		PIPE BRANCH BOTTOM CONN
SAN	SANITARY (BEL. FLR.)	C	PIPE CAP (OR PLUG)
<u> </u>	SANITARY VENT	\oslash	PRESSURE GAUGE
cw	DOMESTIC COLD WATER	<u> </u>	P-TRAP (PLAN VIEW)
SW	SOFTENED COLD WATER	<u>co</u>	WALL OR EXPOSED CLEANOU
— нw ——	DOMESTIC HOT WATER	<u>co</u> O <u> </u>	FLOOR OR GRADE CLEANOUT
D	DRAIN	<u>vtr</u>	VENT-THRU-ROOF
	BALL VALVE	ED	FLOOR DRAIN
— • ••	OS&Y GATE VALVE	42	PIPE THRU FLOOR AS SHOW
	PLUG VALVE/GAS COCK	#	PLAN CODED NOTE NUMBER
>	COMB. BALANCE/SHUTOFF VALVE	#	EQUIPMENT NUMBER
	PRESSURE REDUCING VALVE SOLENOID VALVE	RM#	ROOM NUMBER
	CHECK VALVE	A	STACK SYMBOL
	Y-TYPE STRAINER	SHEET	
	PIPE FLANGES	(1)	
I	PIPE UNION	SHEET	RISER SYMBOL
C	PIPE DOWN	Ŭ	
o	PIPE UP		


PLUMBING	EQUIPMENT
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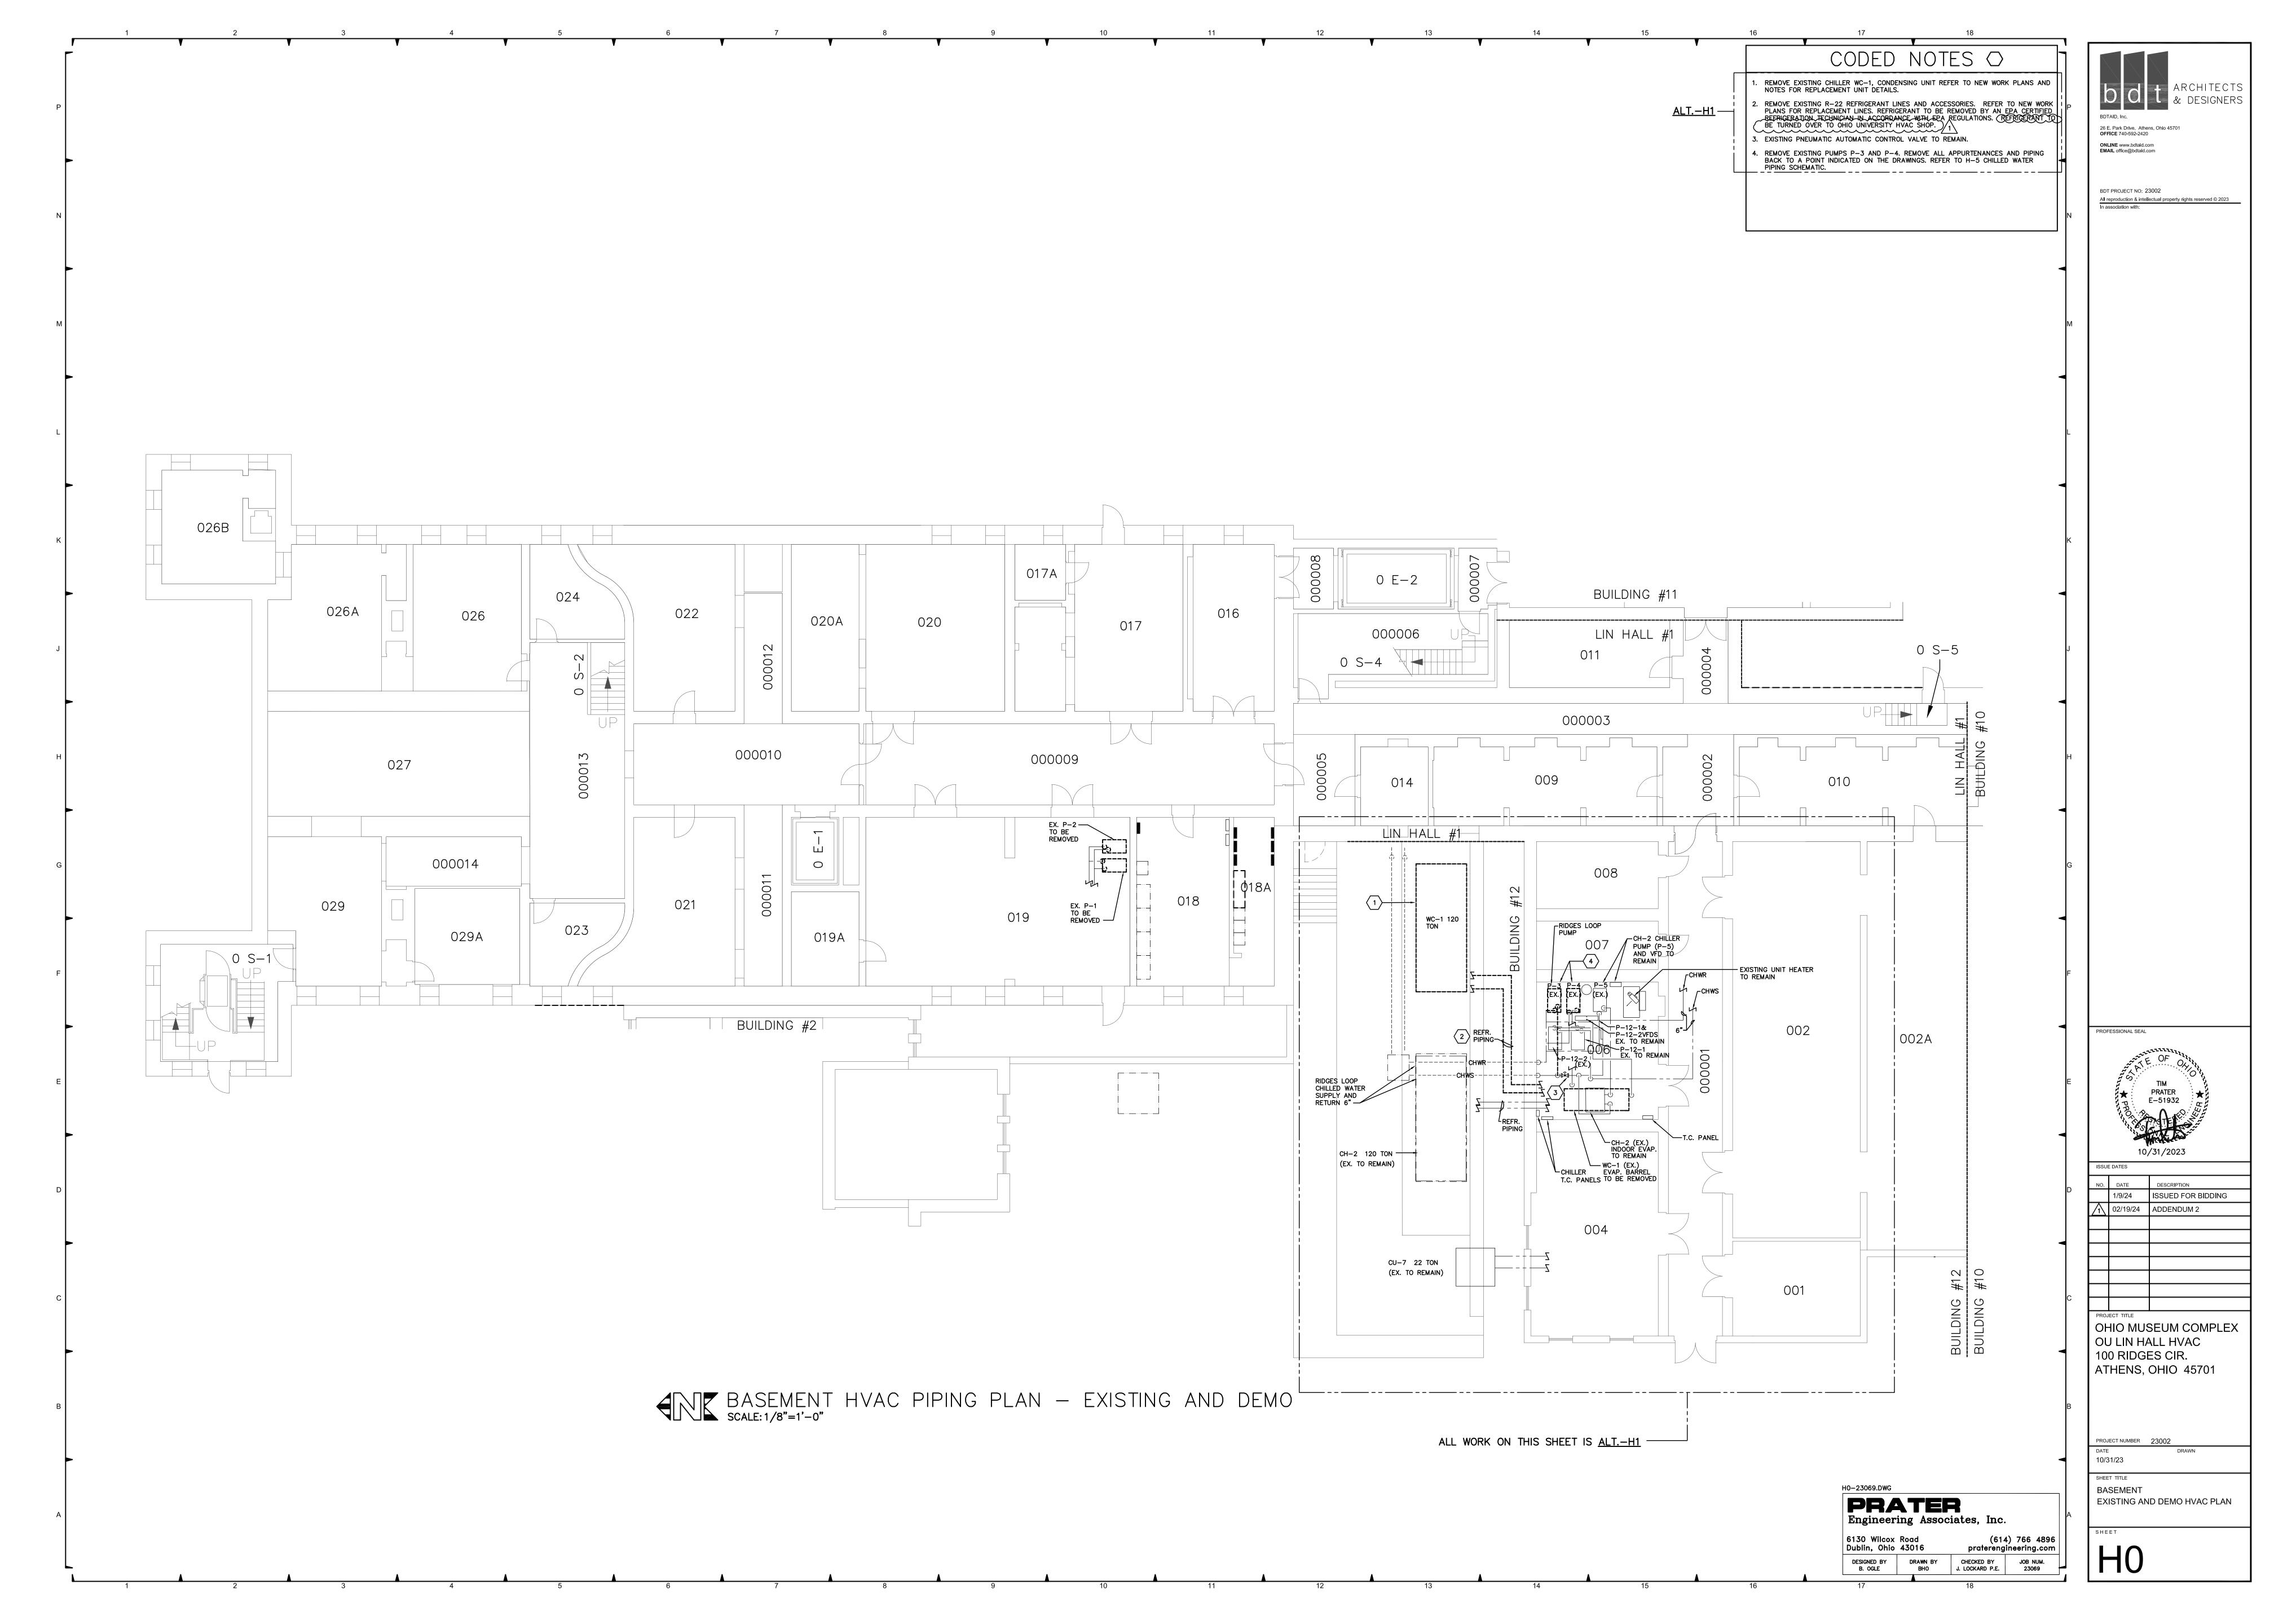
PRECISION PLUMBING PRODUCTS MODEL NO. PR-500 AUTOMATIC PRESSURE DROP ACTIVATED TRAP PRIMER VALVE WILL PRIME UP TO 2 FLOOR DRAINS W/PATENTED DISTRIBUTION DU-U OR DU-4 DISTRIBUTION UNITS. SYSTEM OPERATING RANGE IS 20 PSI MINIMUM TO 80 PSI MAXIMUM. THE VALVE REQUIRES A 3 PSI (21 KPA) PRESSURE DROP ACROSS THE VALVE TO ACTIVATE AND WILL DELIVER A METERED AMOUNT OF WATER TO THE FLOOR DRAIN. TRAP PRIMER IS TO BE CONNECTED TO A COLD WATER SUPPLY ONLY CONSTRUCTED OF 693 BRASS, EPDM E70 O-RINGS, DOW #7 SILICONE, #60 STAINLESS STEEL


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	PIPING SCHEDULE
PIPING TYPE	DESCRIPTION
DOMESTIC HOT WATER, DOMESTIC COLD WATER, SOFTENED WATER, AND TRAP PRIMER SUPPLY	TYPE L HARD TEMPER COPPER PIPE WITH WROT COPPER SOCKET SOLDER FITTINGS. SOLDER MATERIALS TO BE "LEAD FREE".
	PIPING TO BE RATED FOR 125 PSIG WORKING PRESSURE AT 140 DEGREES F. MAXIMUM WATE TEMPERATURE.
	ALL COPPER PIPING RUN THROUGH STUDS OR OTHER CONSTRUCTION ELEMENTS IN FRAMED STRUCTURES SHALL BE PROVIDED WITH PROTECTIVE STEEL STRIKER PLATES WHEN PIPING II WITHIN 1 1/2" FROM THE EDGE OF THE FRAMING MEMBER. THE STRIKER PLATES SHALL COM WITH OHIO PLUMBING CODE REQUIREMENTS.
SANITARY WASTE, SANIT- ARY VENT AND STORM DRAIN	STANDARD WEIGHT CAST IRON DWV NO-HUB PIPE WITH CAST IRON DWV NO-HUB FITTINGS A NEOPRENE GASKET STAINLESS STEEL BAND COUPLINGS.

-	0 -		
		DRAIN	& CLEANOUT SCHEDULE
	DES.	LOCATION	DESCRIPTION
	FD-1	FLOOR DRAIN	ZURN MODEL NO. Z-610 CAST IRON FLOOR DRAIN WITH SECONDARY DRAINAGE/AN- CHOR FLANGE, WEEPHOLES, COATED FRAME & GRATE, 12" SQUARE TOP WITH SLOT OPENINGS, REMOVABLE SEDIMENT BUCKET & BOTTOM GASKET CONNECTION OUTLET. DRAINS IN STRUCTURES ABOVE GRADE TO BE FURNISHED WITH CLAMPING COLLAR.
	C.O.	CLEANOUTS	ZURN ZB-1470 FLUSH WITH FLOOR OR WALL AND HAVE COUNTER-SUNK BRASS HEADS.

-23069.DWG			
<b>PR</b> Engineer	ing Assoc	<b>a</b> tes, Inc.	
6130 Wilcox Dublin, Ohio		614) praterengi	) 766 neering
DESIGNED BY M. KOVALCHIK	DRAWN BY M. KOVALCHIK	CHECKED BY C. ANDERSON	JOB N 2300



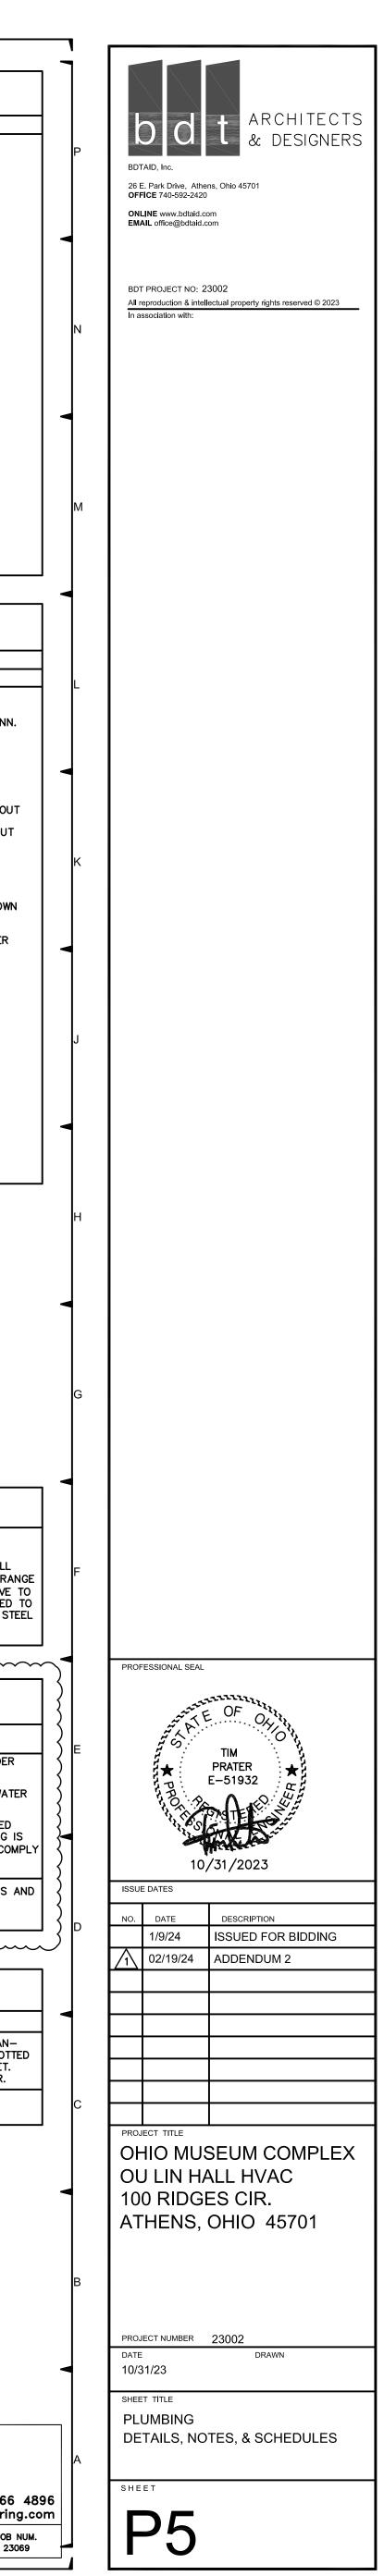

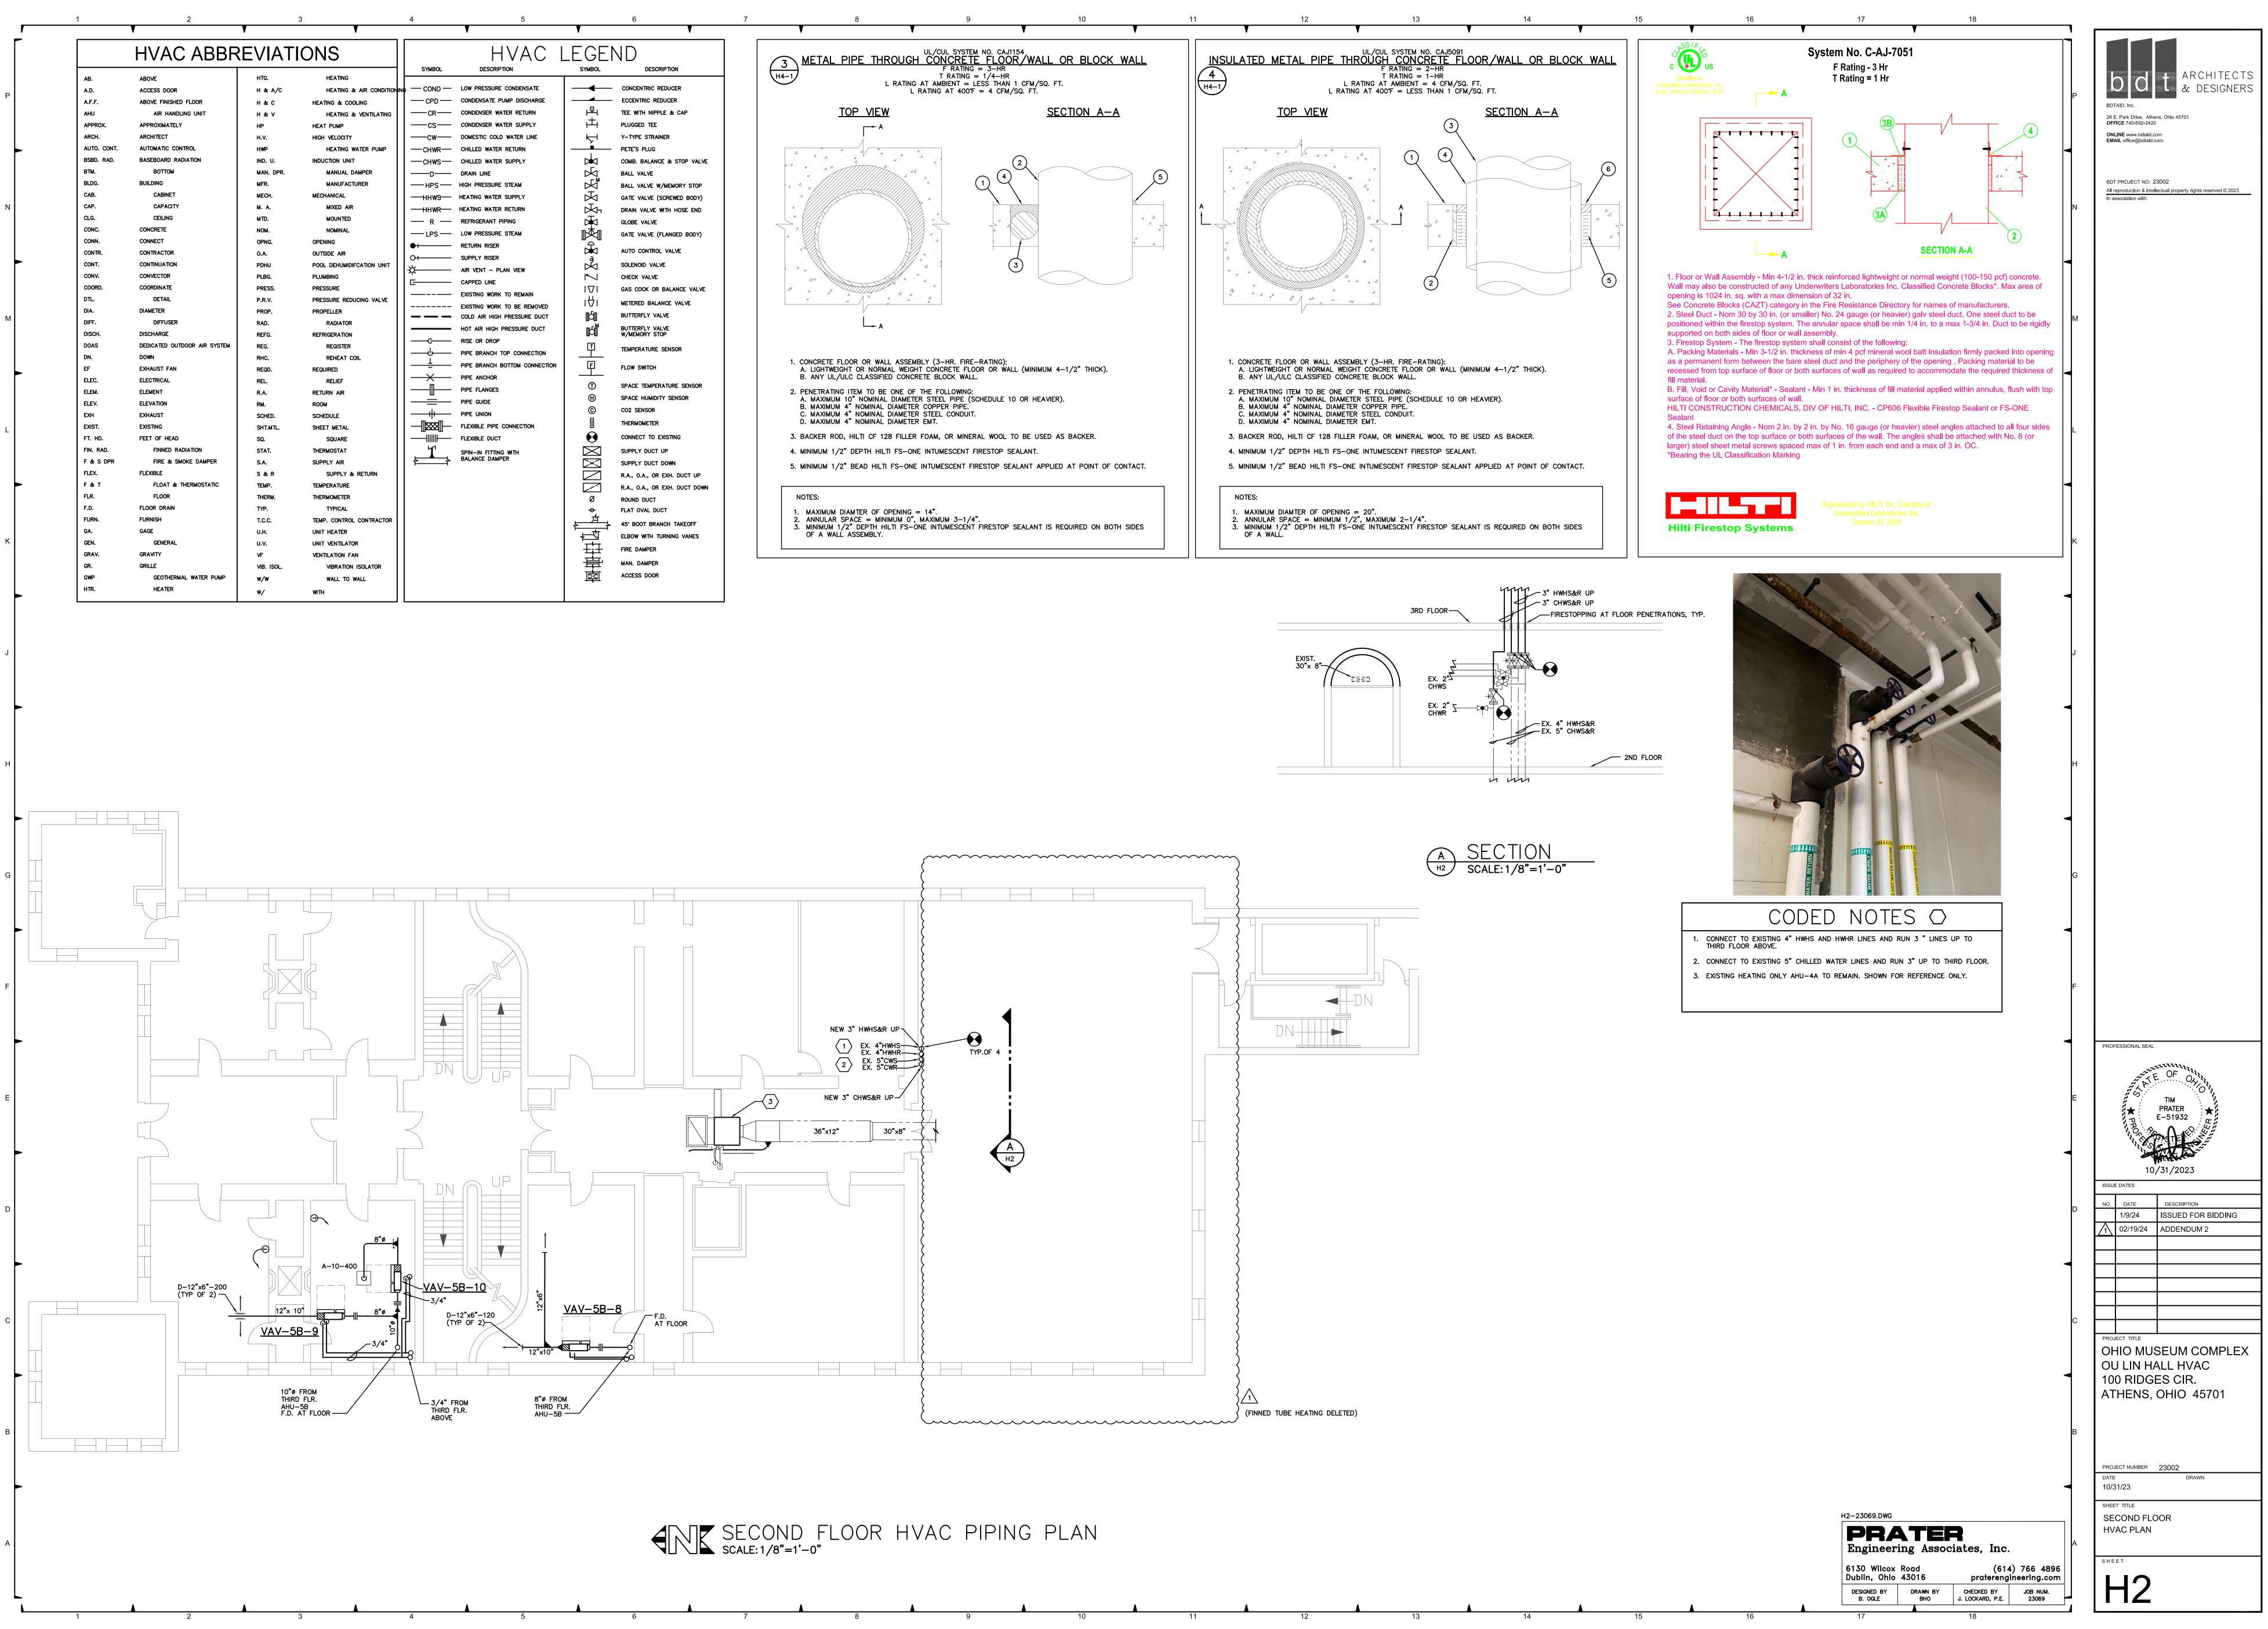

	CODED NOTES 🔿
1.	CONNECT TO EXISTING 4" HWHS AND HWHR LINES AND RUN 3 " LINES UP TO THIRD FLOOR ABOVE.
2.	CONNECT TO EXISTING 5" CHILLED WATER LINES AND RUN 3" UP TO THIRD FLOOR.
3.	EXISTING HEATING ONLY AHU-4A TO REMAIN. SHOWN FOR REFERENCE ONLY.


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<b>PR</b> Engineer		<b>a</b> tes, Inc.	
6130 Wilcox Dublin, Ohio		614) pratereng	4) 766 ineerin
DESIGNED BY B. OGLE	DRAWN BY BHO	CHECKED BY J. LOCKARD, P.E.	JOB 230






WALL AT MONUMENTAL STAIR LOOKING SOUTH (EXIST. PHOTO)


# EXISTING DUCTWORK AT CORRIDOR - SEE DEMO PLAN

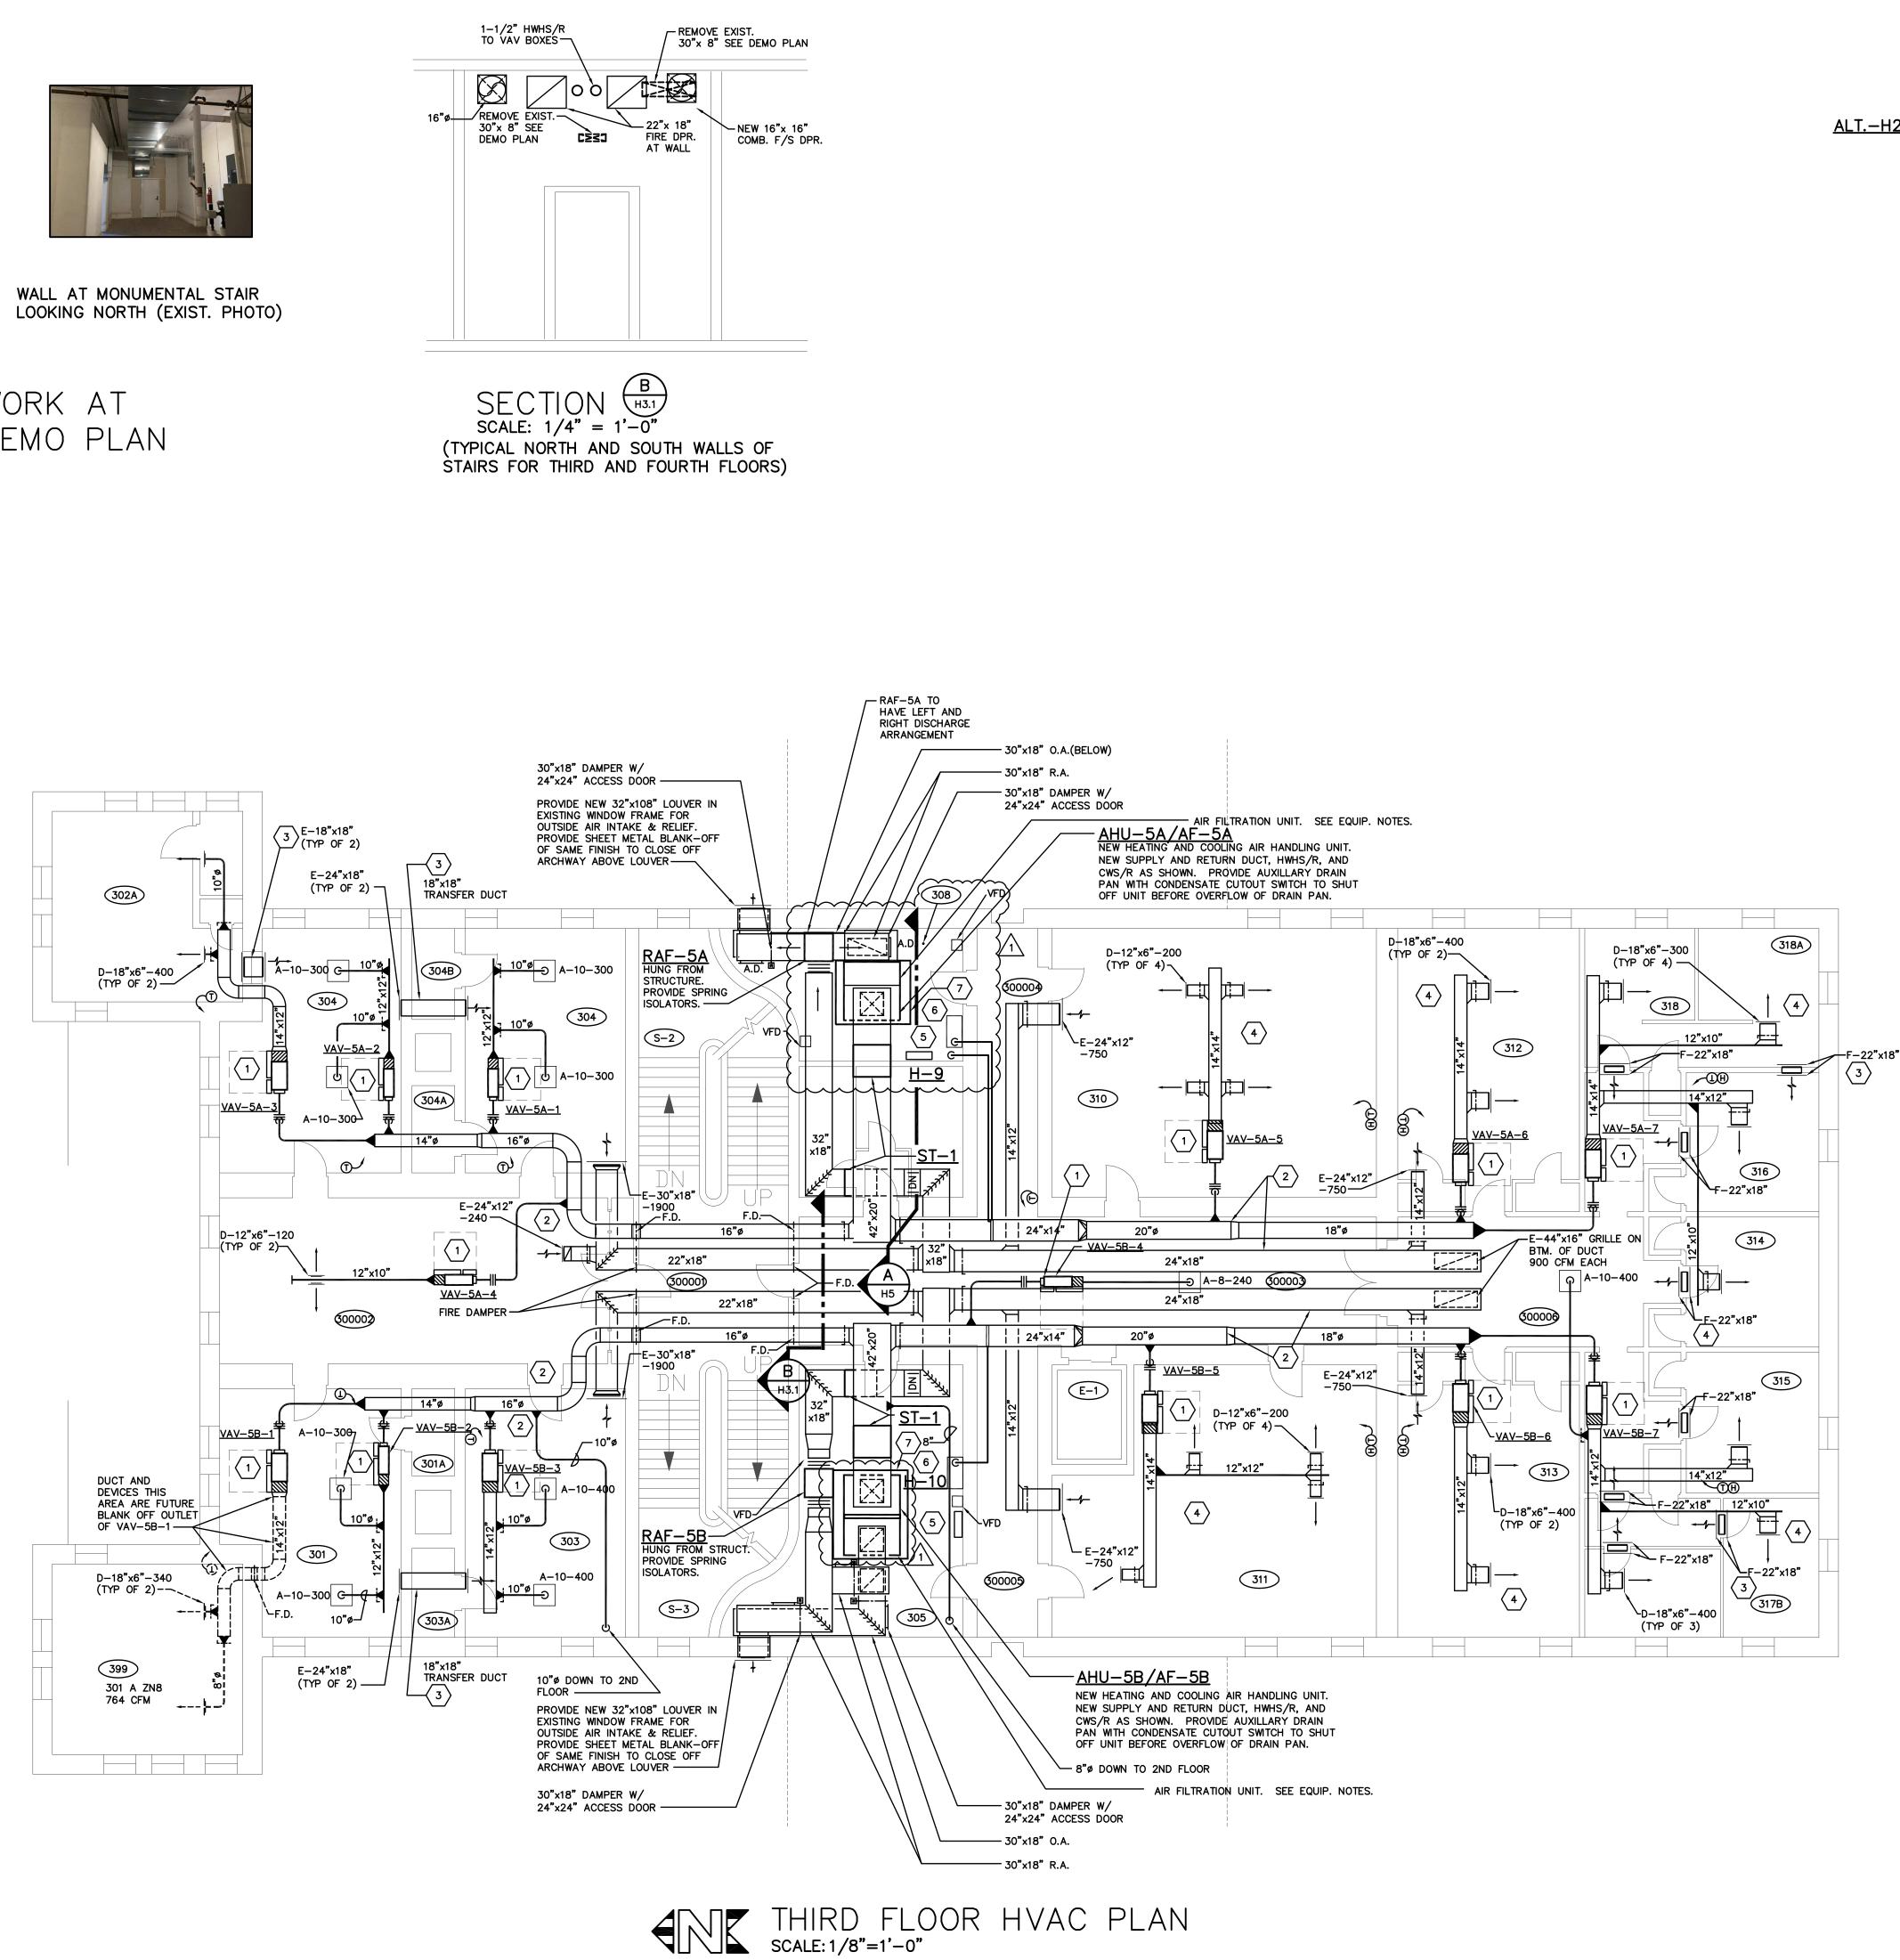


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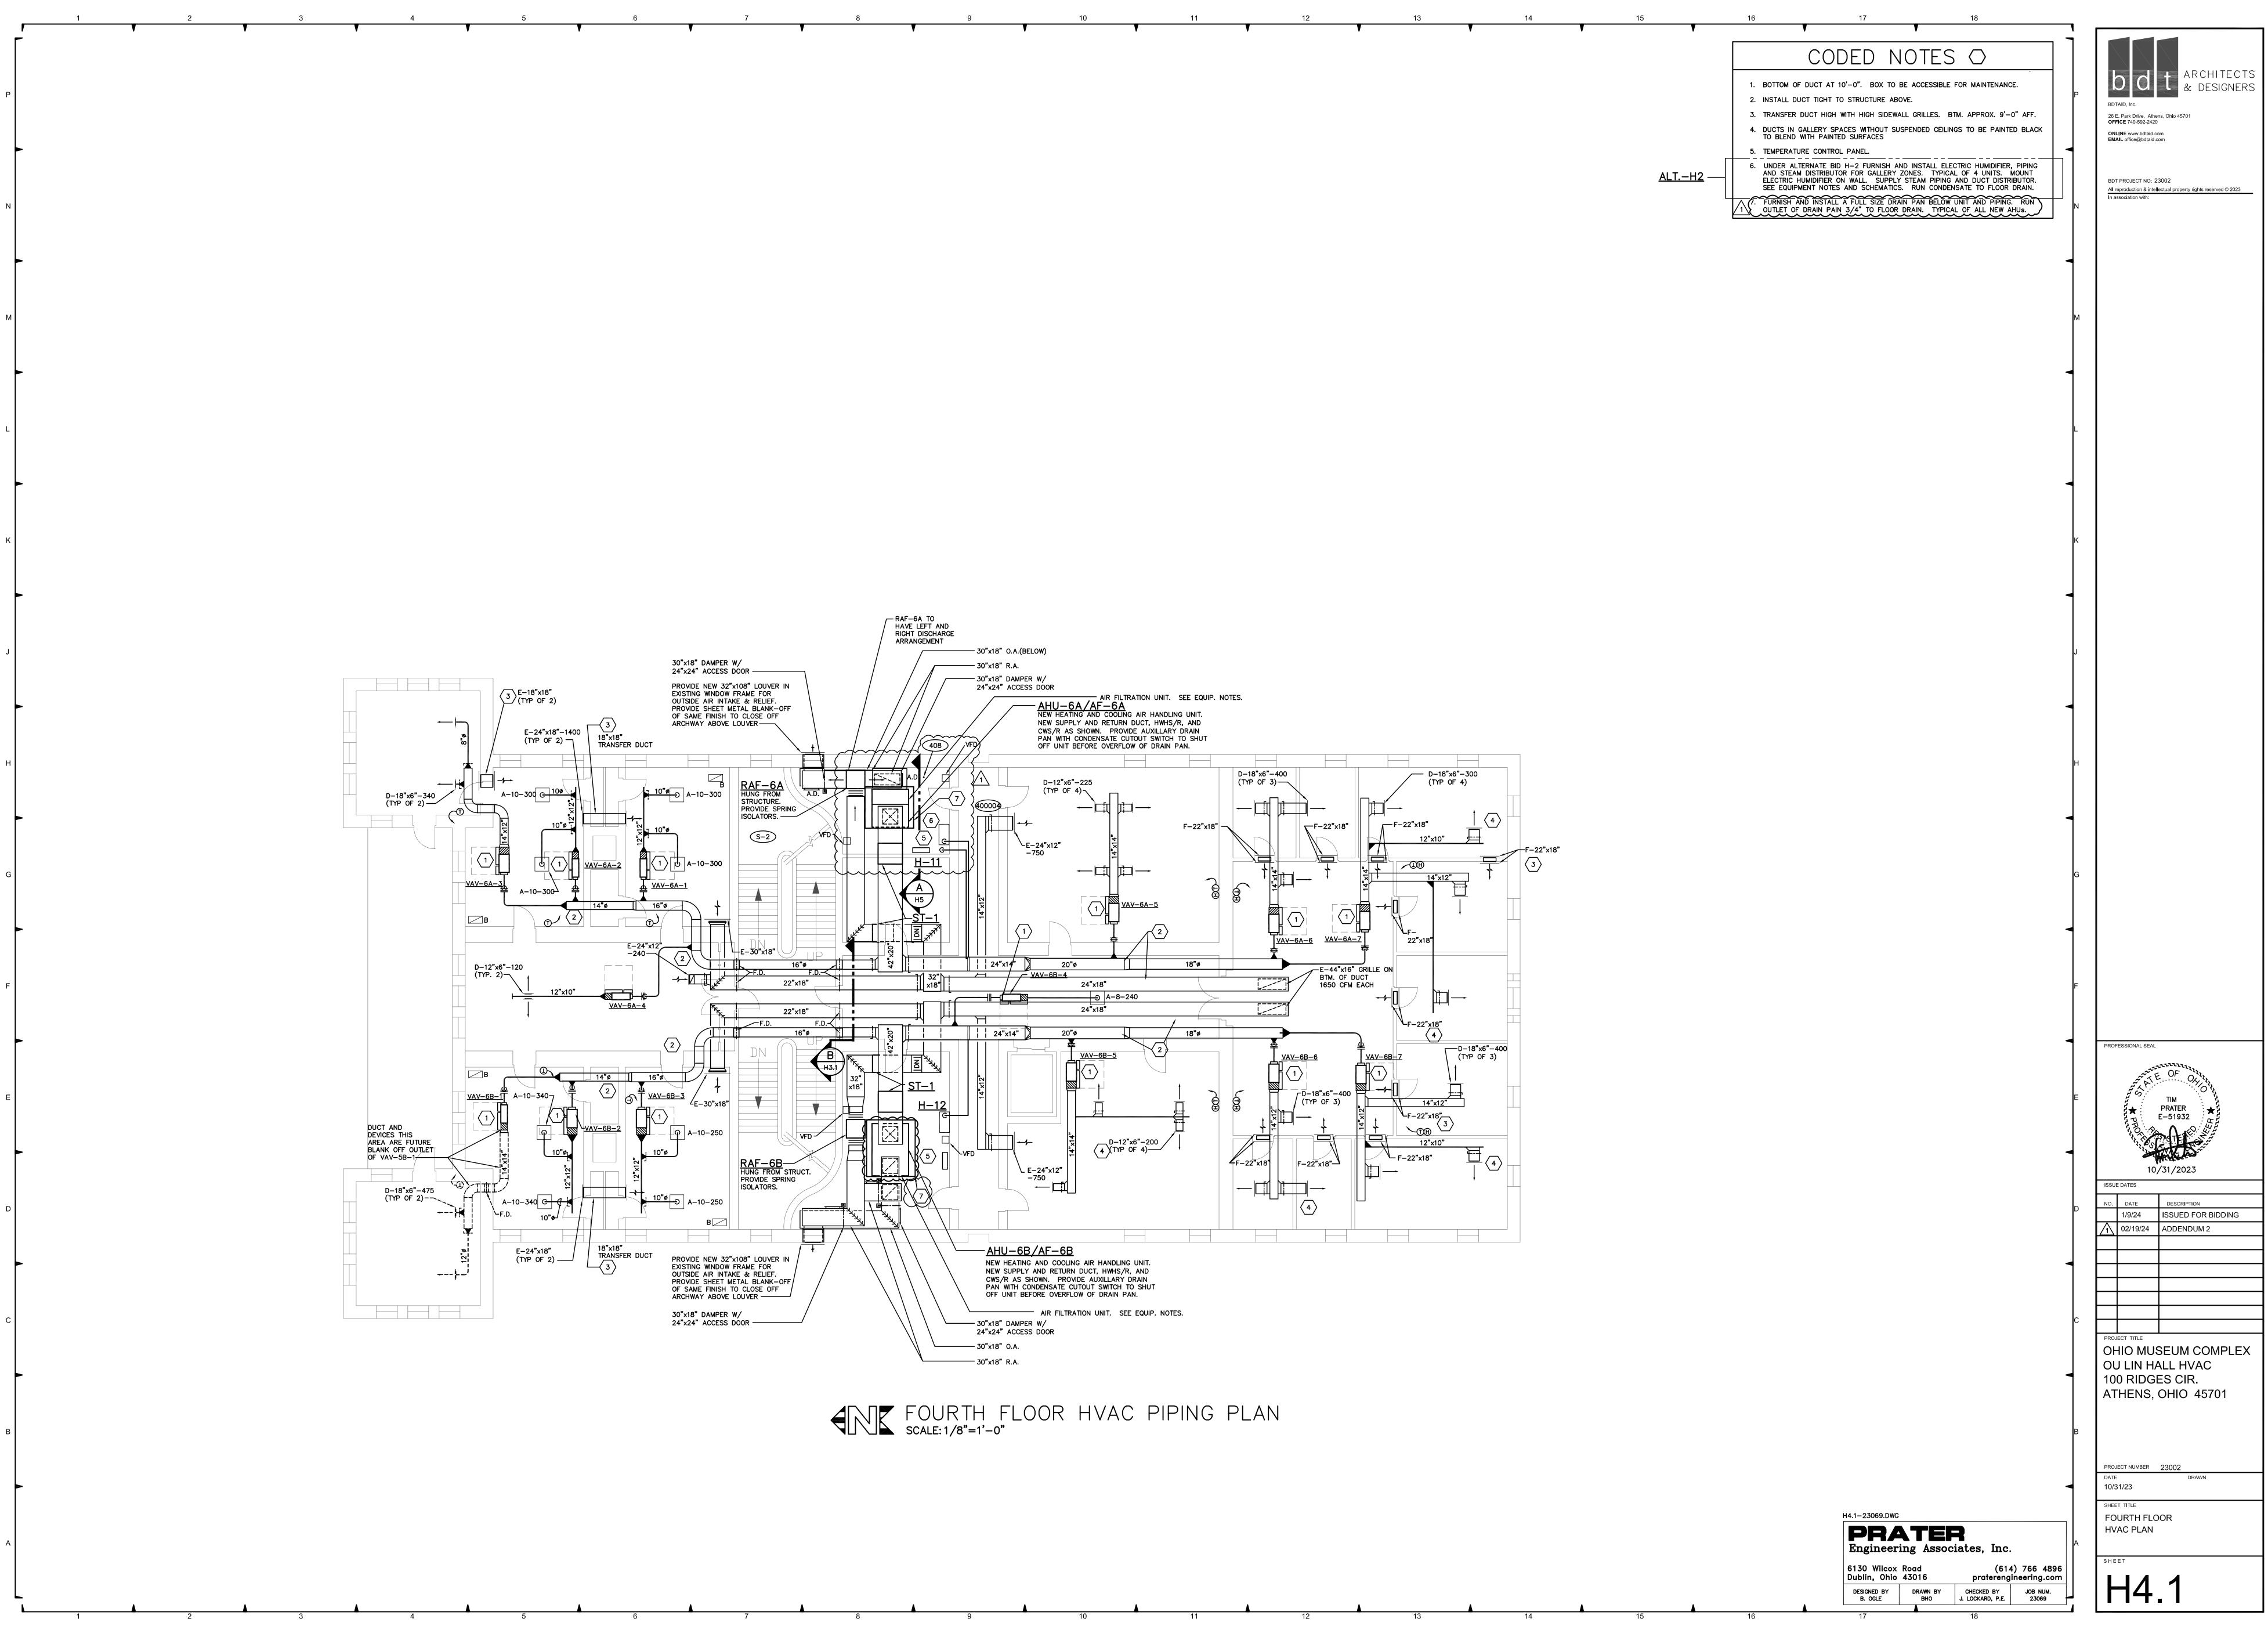

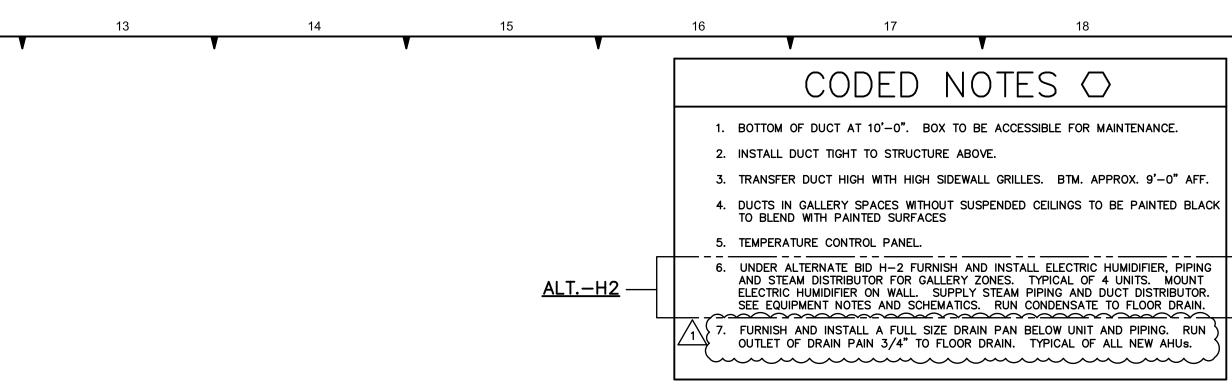
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<b>PR</b> Engineeri		<b>R</b> eiates, Inc.	
6130 Wilcox Dublin, Ohio		614) pratereng	4) 766 ineerin
DESIGNED BY B. OGLE	DRAWN BY BHO	CHECKED BY J. LOCKARD, P.E.	JOB 23
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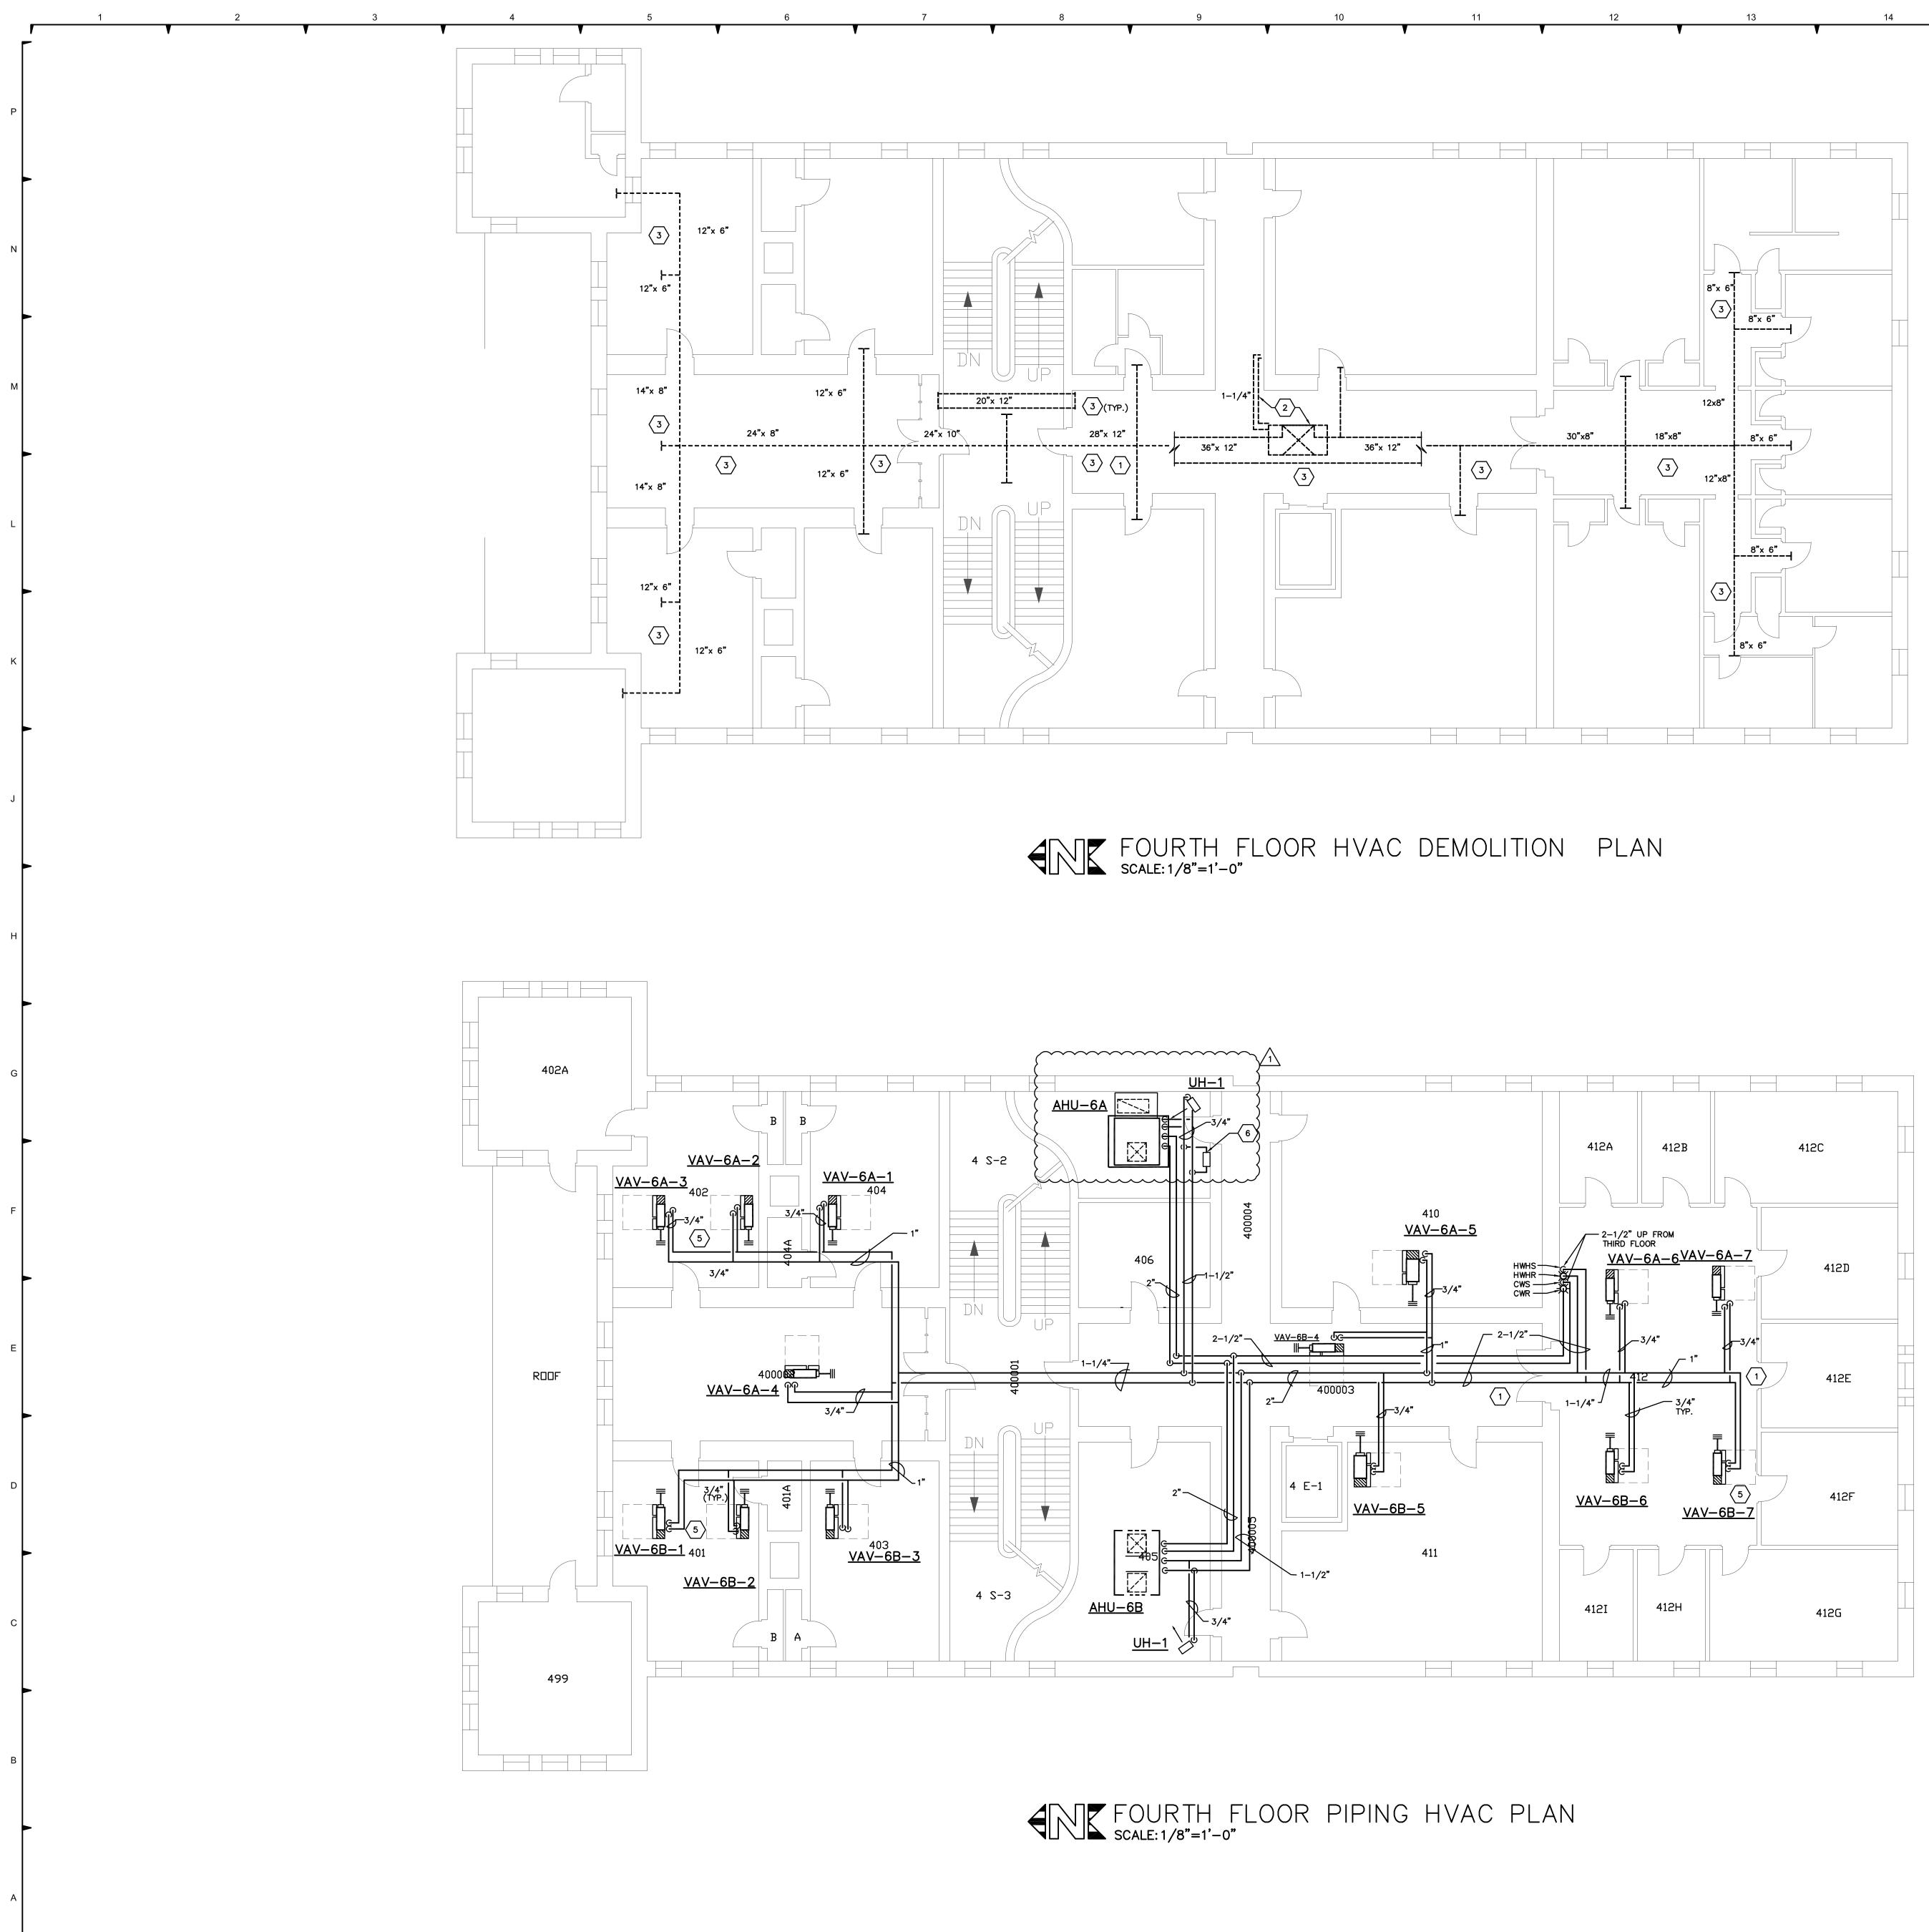


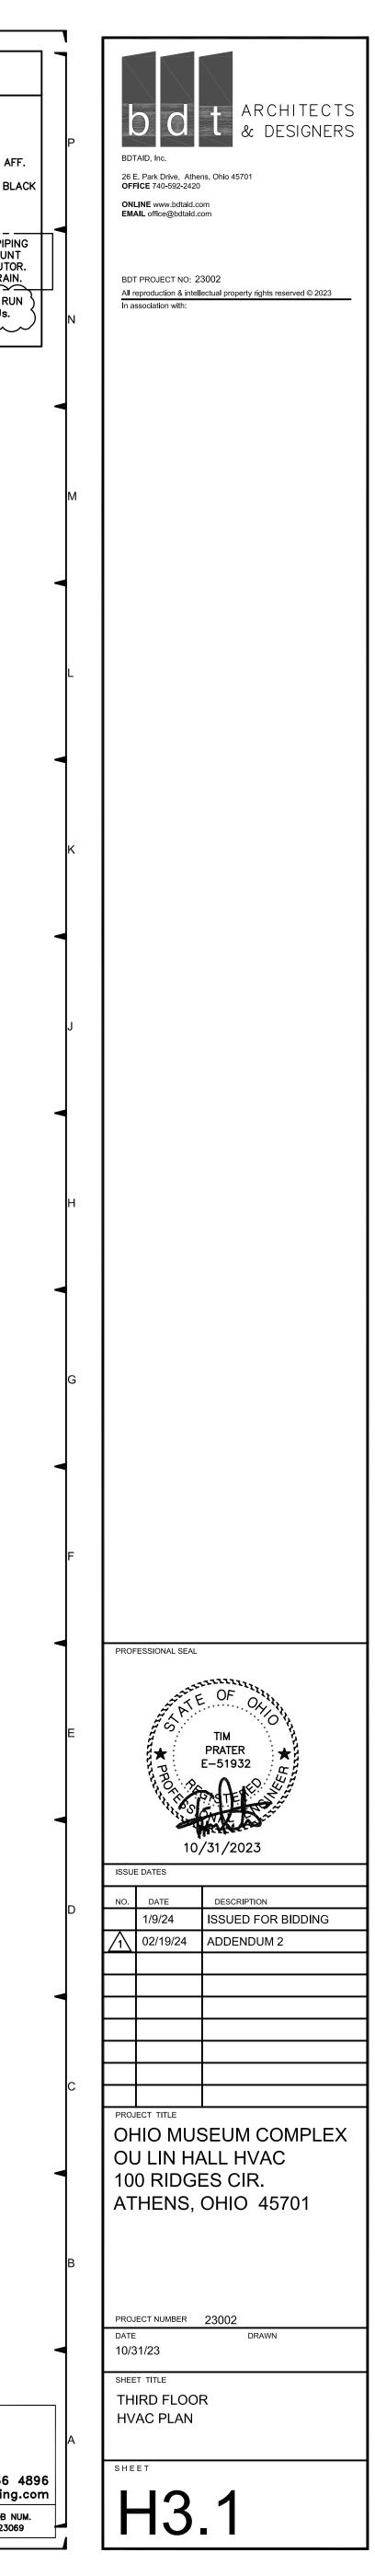

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	Road	ciates, Inc. (614) praterengi	) 766 neering
DESIGNED BY	DRAWN BY	CHECKED BY	JOB
B. OGLE	вно	J. LOCKARD, P.E.	230
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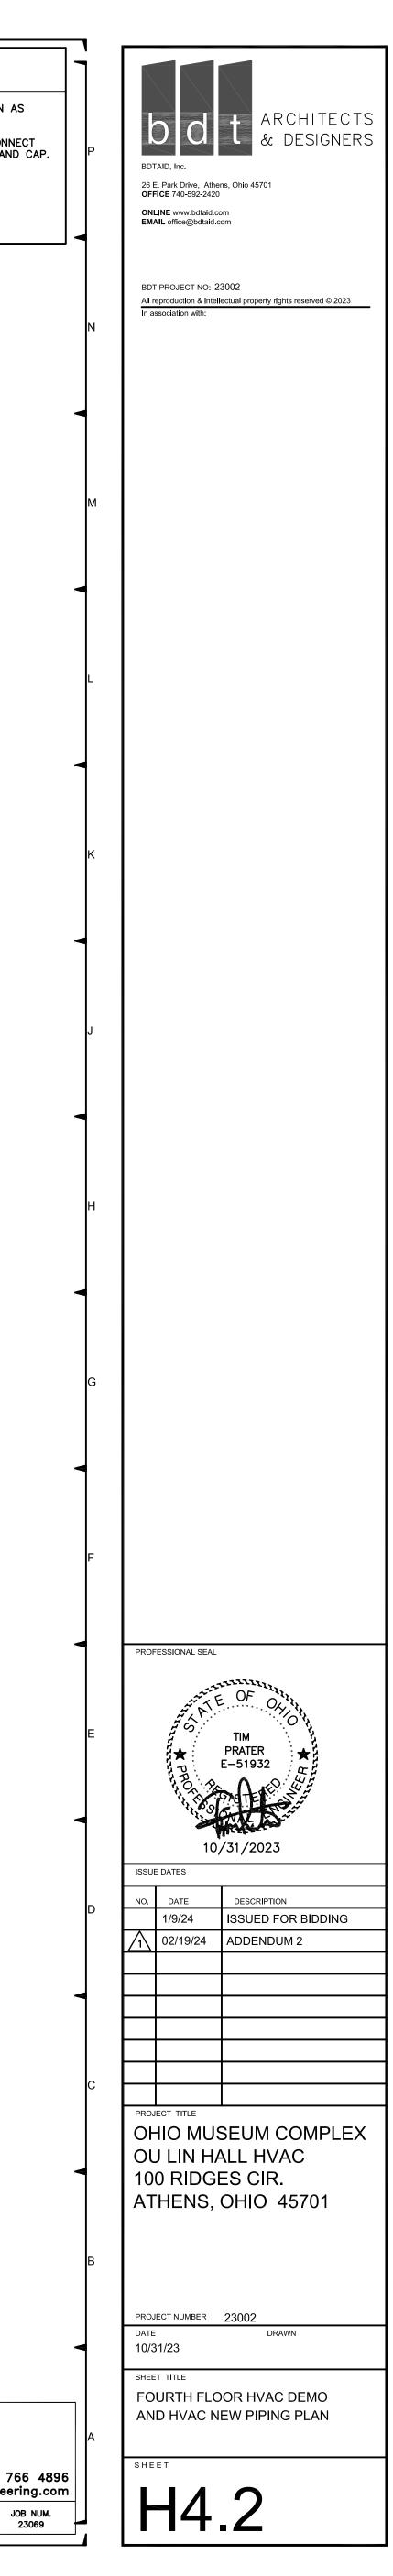
H4.1-23069.DWG			
<b>PR</b> Engineer		<b>a</b> tes, Inc.	
6130 Wilcox Dublin, Ohio		614) pratereng	4) 766 ineerin
DESIGNED BY B. OGLE	DRAWN BY BHO	CHECKED BY J. LOCKARD, P.E.	JOB 230
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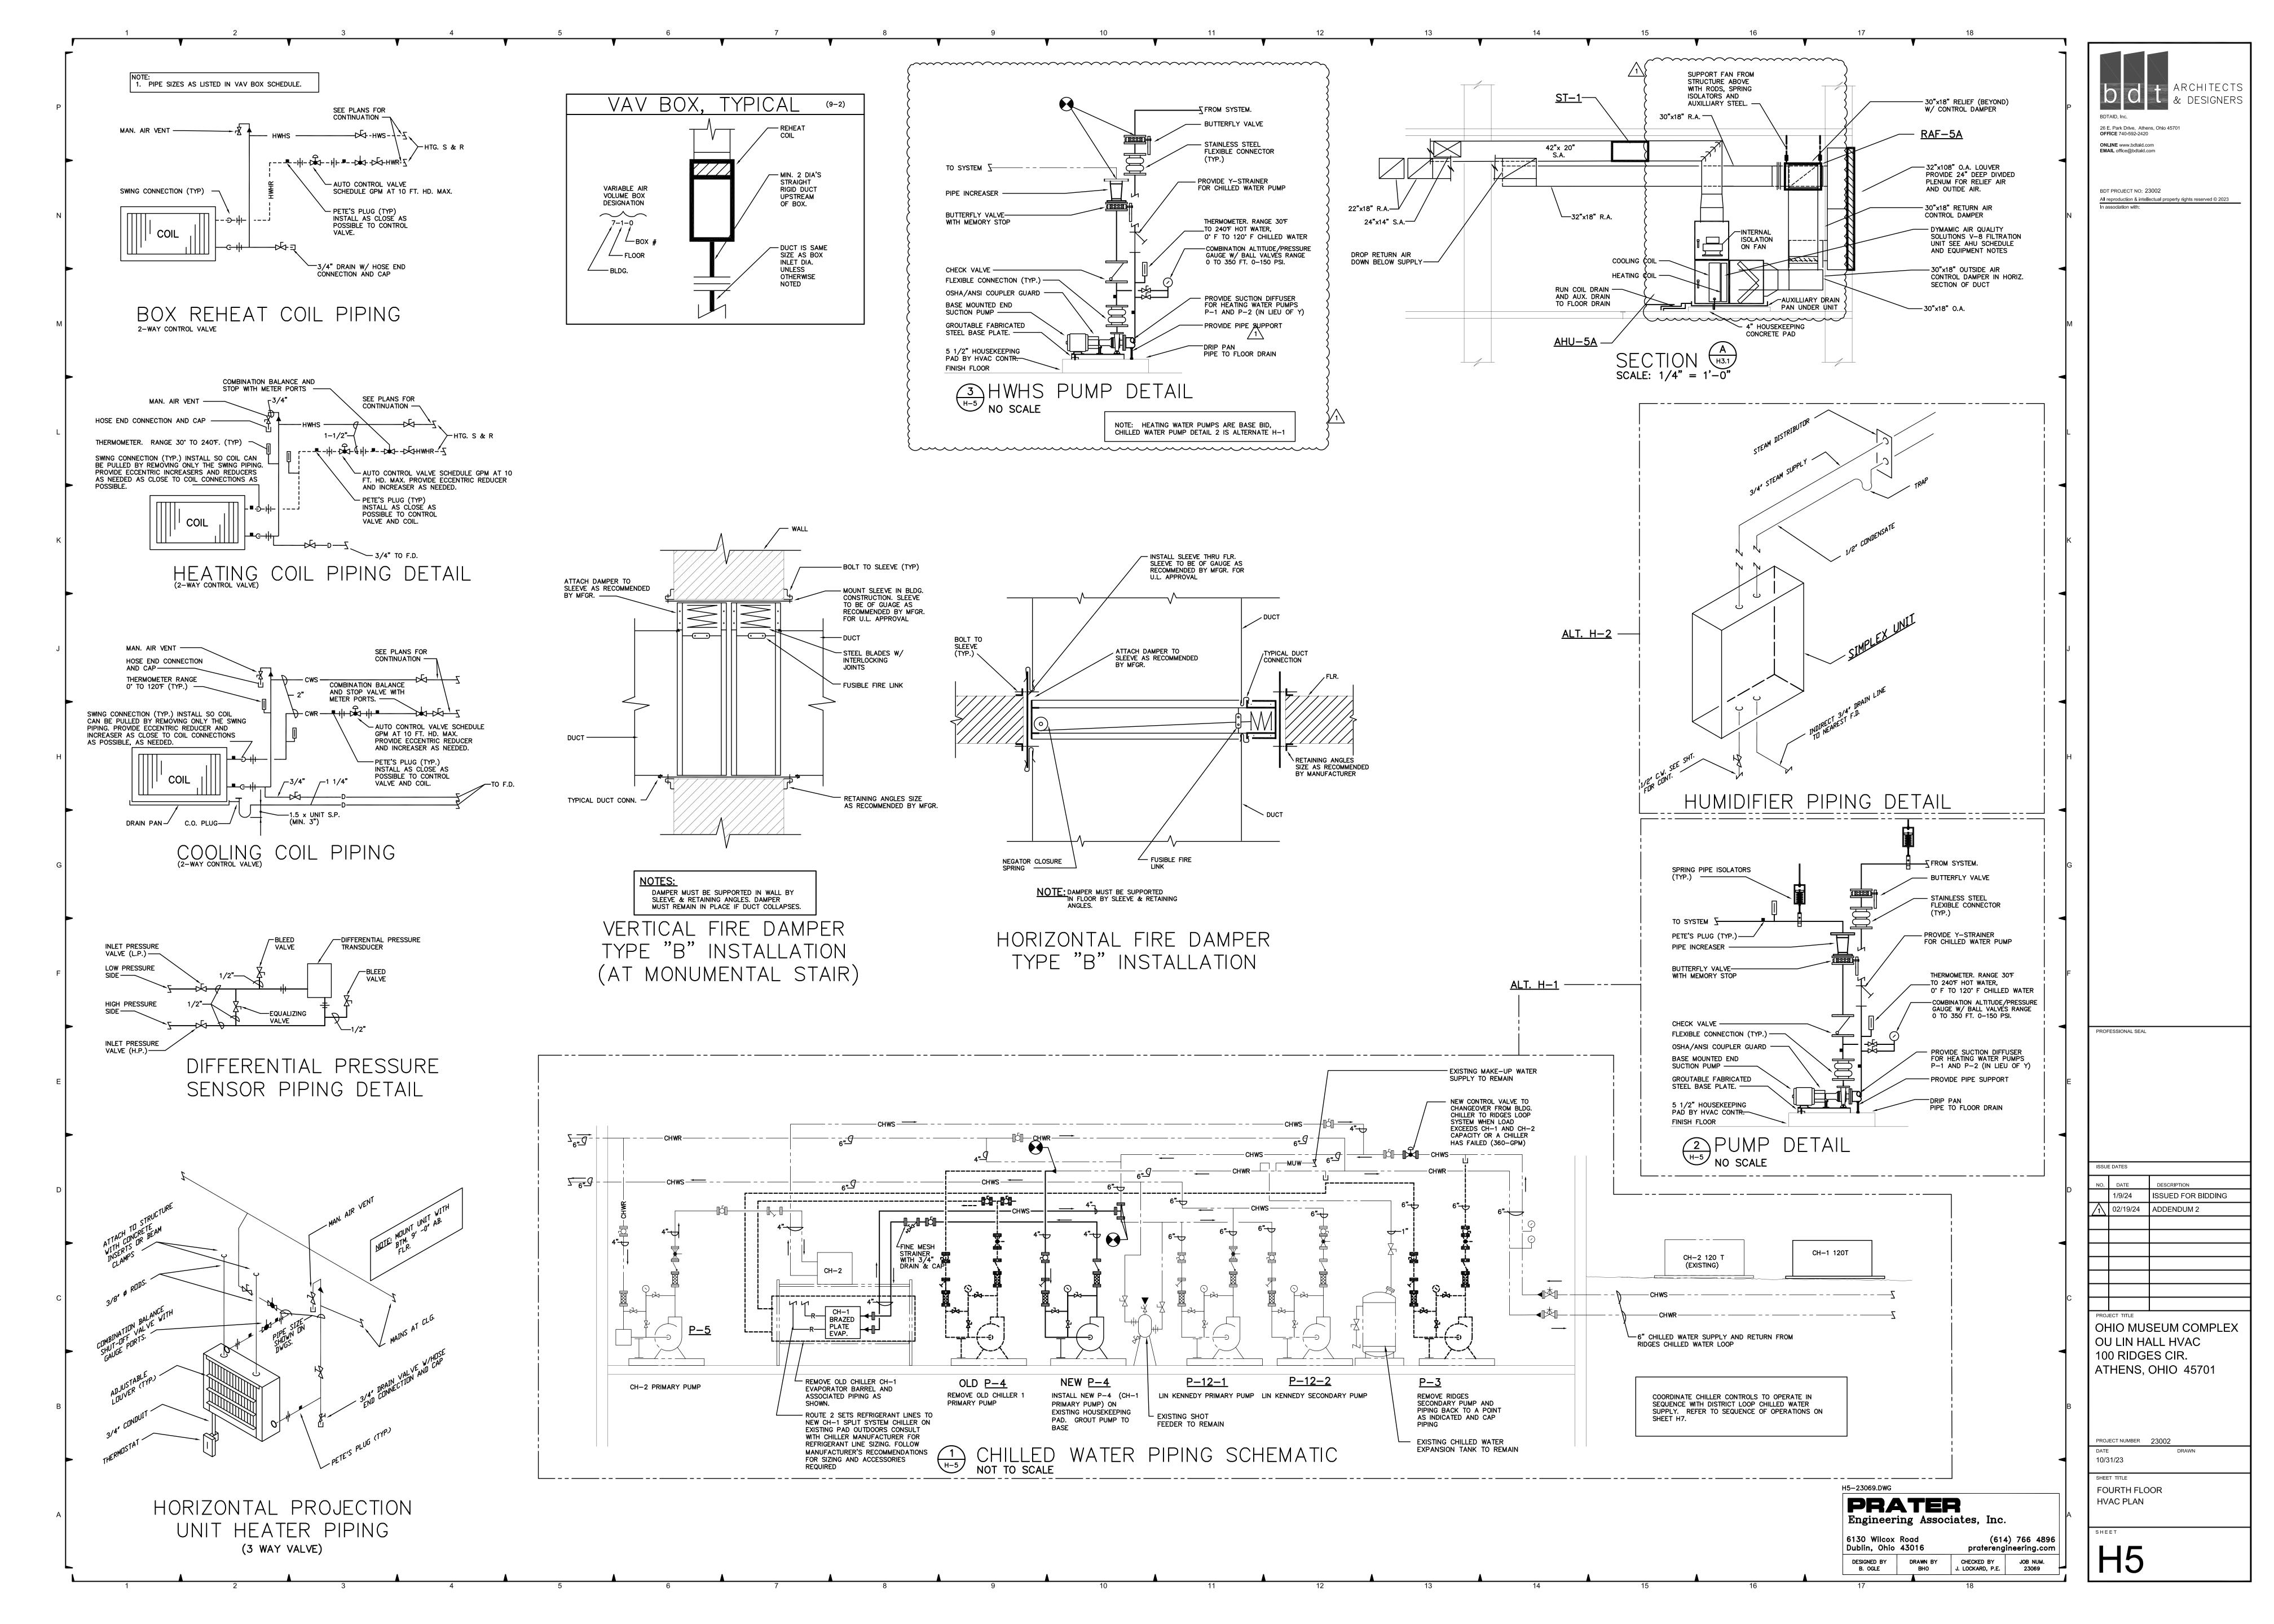


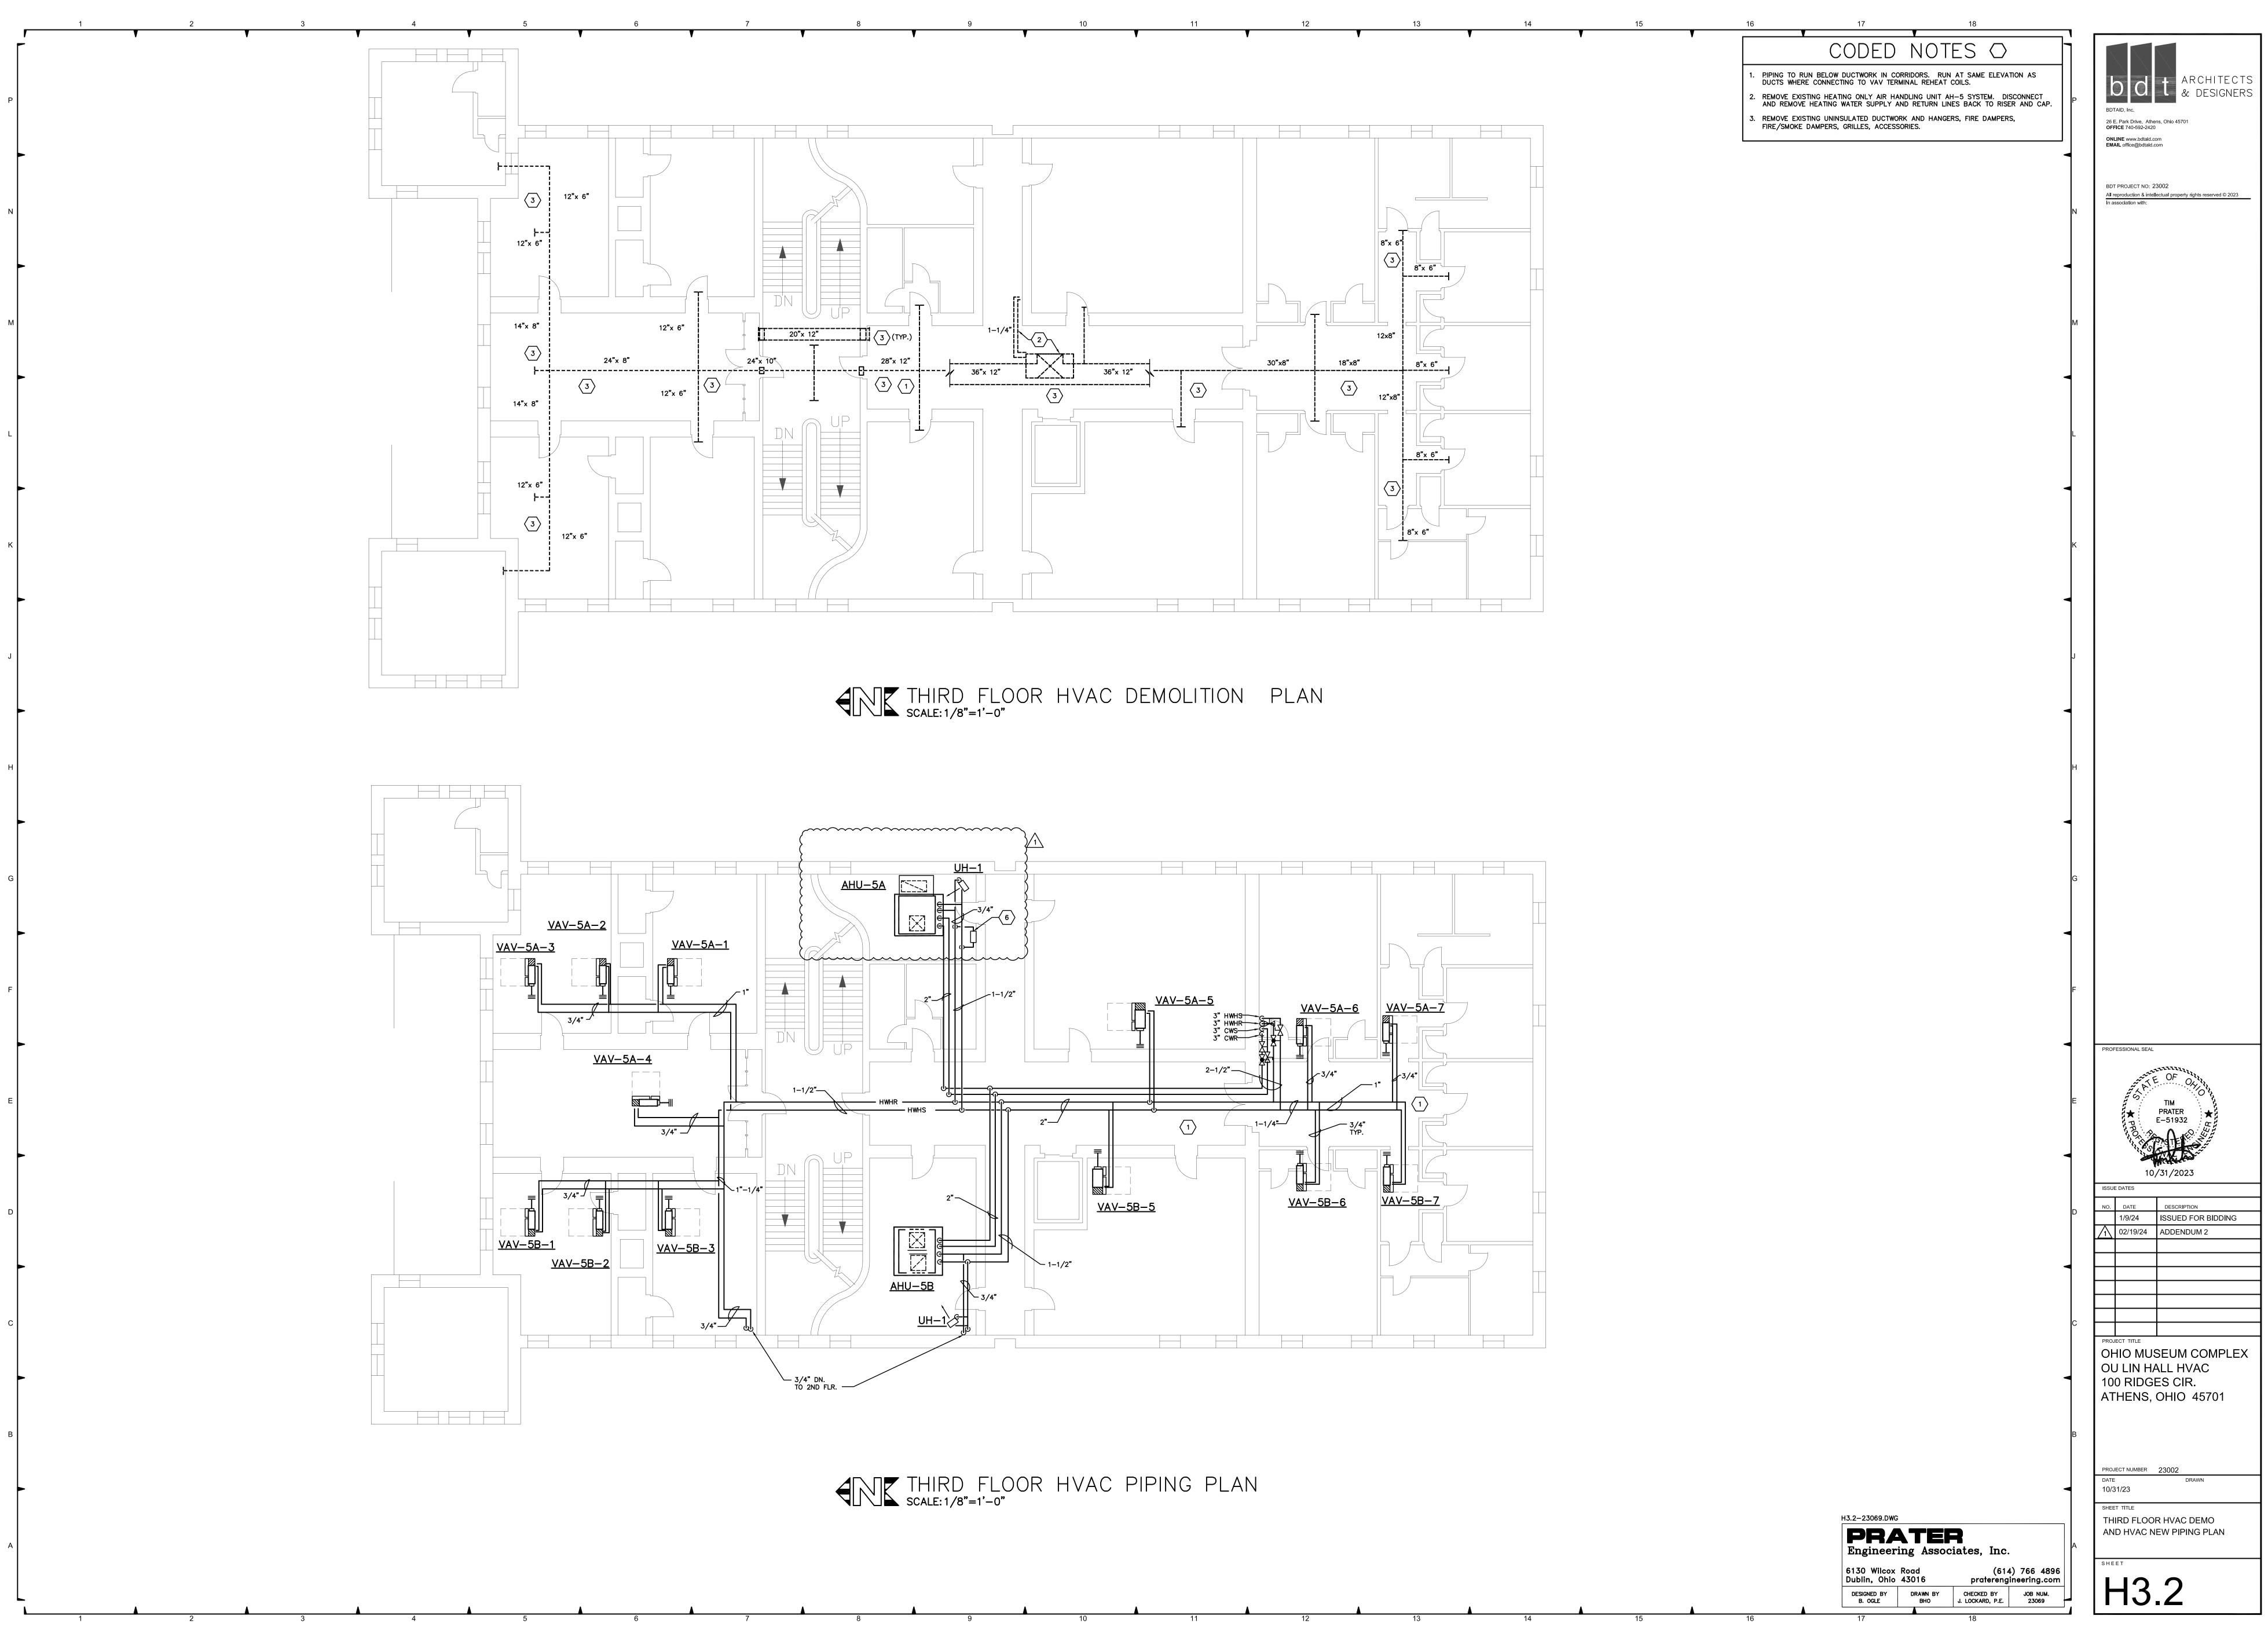
16	17	18
	CODED	NOTES O
1.	PIPING TO RUN BELOW DUCTWORK IN COR DUCTS WHERE CONNECTING TO VAV TERM	
2.	REMOVE EXISTING HEATING ONLY AIR HAN AND REMOVE HEATING WATER SUPPLY AN	
3.	REMOVE EXISTING UNINSULATED DUCTWOR FIRE/SMOKE DAMPERS,GRILLES, ACCESSOR	· · · · · · · · · · · · · · · · · · ·
4.	DIFFERENTIAL PRESSURE TRANSMITTER.	

5. THREE WAY CONTROL VALVE.

H4.2-23069.DWG	;		
<b>PR</b> Engineer 6130 Wilcox Dublin, Ohio	ing Assoc	iates, Inc. (614 pratereng	
DESIGNED BY B. OGLE	DRAWN BY BHO	CHECKED BY J. LOCKARD, P.E.	JOB 230






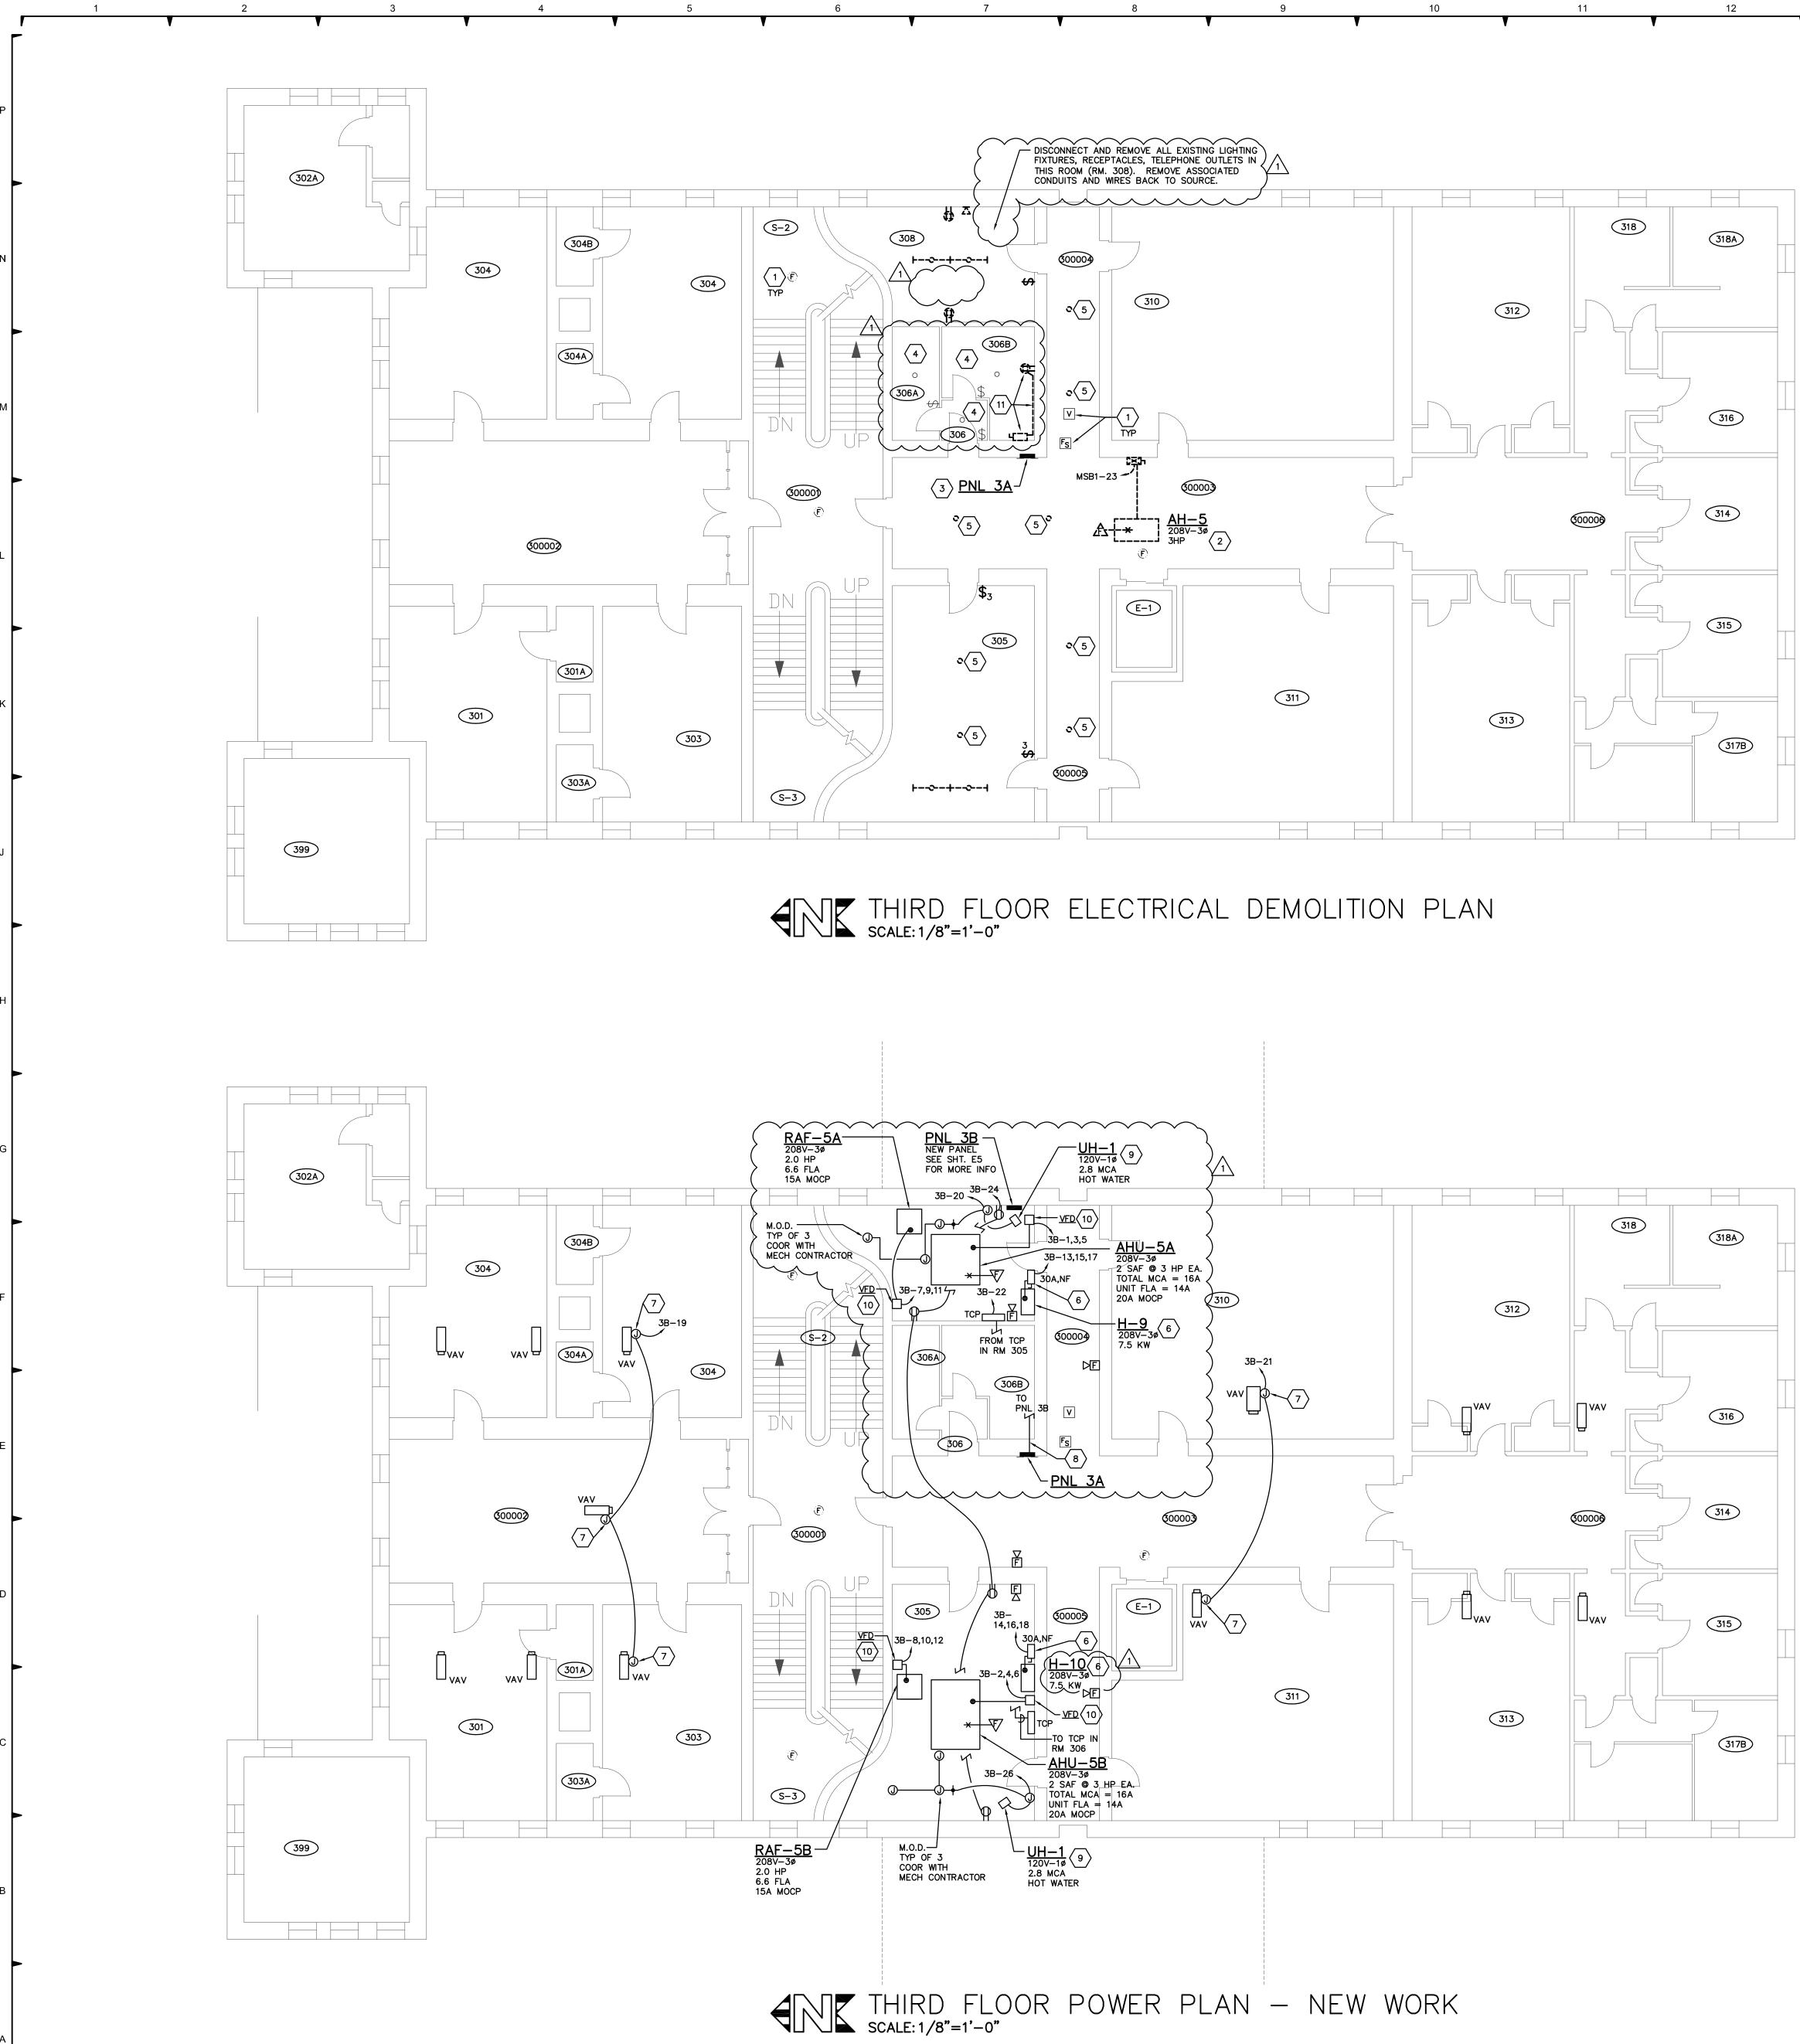


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·	•	v		¥	GENERA	L NOTES	
			Α.	COORDINATE		ES FOR RELATED ELECTRICAL WORK REQ	UIRE
			В.	SWITCH AND/	OR VFD. COORDINATE WIT	RECEDENCE OVER PLACEMENT OF DISCON TH OTHER TRADES IN FIELD PRIOR TO TO MOUNTING LOCATION OR HEIGHT AS	NEC
			с.			OVIDE ALL ADDITIONAL STEEL, HANGERS, ER INSTALLATION AND SUPPORT OF NEW	
PA	<u>NEL 3A</u>		D.	RELATED PEN		DNSIBLE FOR FIRE STOPPING AT ALL ELEC E AND OTHER RATED STRUCTURES, INCL	
					CODED	NOTES 🔿	
			1.	EXISTING TO	REMAIN. SHOWN FOR RE	FERENCE ONLY.	
		FEEDER TO PANEL 4A	2.	TO DISCONN	ECT AND REMOVE DISC SW	D BY MECH CONTRACTOR. THIS CONTRA ITCH, REMOVE ASSOCIATED ACCESSIBLE D DUCT SMOKE DETECTOR) BACK TO SO	
P G			3.	FROM MSB I REMOVE FEE FEEDER. SE BRANCH CIR LIGHTING IN	N BASEMENT IS SPLICED V DER FROM MSB, PROTECT E PHOTO ON THIS SHEET CUITS SHALL REMAIN EXCE	EFED FROM NEW POWER SOURCE. FEED WITH THAT OF PANEL 4A IN THIS PANEL. FEEDER FOR PANEL 4A FOR SPLICE WITH FOR EXISTING CONDITION. ALL EXISTING EPT THOSE SERVING RECEPTACLES AND SA, 306B AND 308. SEE PHOTO ON THI	H NI
			4.		G TO REMAIN UNLESS NOT	CONNECT SWITCH, ETC. SHOWN IN THIS F	×001
			5.	CONDUIT AN LIGHT SWITC PROVIDE JUI	D WIRES BACK TO SOURCE H(ES) ALSO SERVE LIGHTIN	CHTING FIXTURES. REMOVE ASSOCIATED E. REMOVE ASSOCIATED LIGHT SWITCH(E IG FIXTURES BEYOND AREA OF DEMOLITIC ROL TO EXISTING TO REMAIN FIXTURES.	
		ALTH2 NOTES	<u>S</u> 6.	HUMIDIFIER.		C SWITCH AND CIRCUIT FOR ELECTRIC OCATION WITH MECH CONTRACTOR IN FIE DNNECTION TO EQUIPMENT.	ELD
		FEEDER FROM MSB	7.	TRANSFORME COORDINATE	R AND WIRING FURNISHED	TO SIX LOCATIONS FOR VAV CONTROLS. BY TEMP CONTROL CONTRACTOR. HERE 120V CIRCUITS ARE NEEDED WITH	
		FEEDER SPLICE	8.	BACK OF PN	IL 3A (AFTER THE REMOVA 	R THROUGH THE OPENING ON WALL AND AL OF DISC SWITCH). PROVIDE LUGS TO SR FOR RIVE 4A. SEE PHOTO ON THIS S R CONDUIT FROM PANEL 3B SHALL BE VE PRIOR TO TURNING DOWN TO PANEL	SPI SHEE
			9.	DISC SWITCH	FURNISHED WITH UNIT HE	ATER BY MECH CONTRACTOR.	
	C SWITCH		10.		HED BY MECH CONTRACTOR R. COORDINATE WITH MEC	R, INSTALLED AND WIRED BY ELEC H CONTRACTOR IN FIELD.	
	FROM PANEL 3A ROOM 306B)			EXISTING TO	BE REMOVED.	~~~~~~~~~~~~~~~~~~~~~~~~~~~~~~~~~~~~~~~	$\frown$
				EQUIPMENT	AND DUCTWORK IN THIS R FIXTURES. LIGHT FIXTURE IT BELOW DUCT WORK AS	G HEIGHT AND LOCATION WITH HVAC DOM. DUCTWORK SHALL HAVE PRECEDEN S MOUNTING HEIGHT SHALL BE MINIMUM NECESSARY. COORDINATE WITH MECH	
- F			L				

NEW FEEDER FOR PANEL 3A SHALL ENTER THROUGH WALL OPENING AFTER THE REMOVAL OF DISC SWTICH

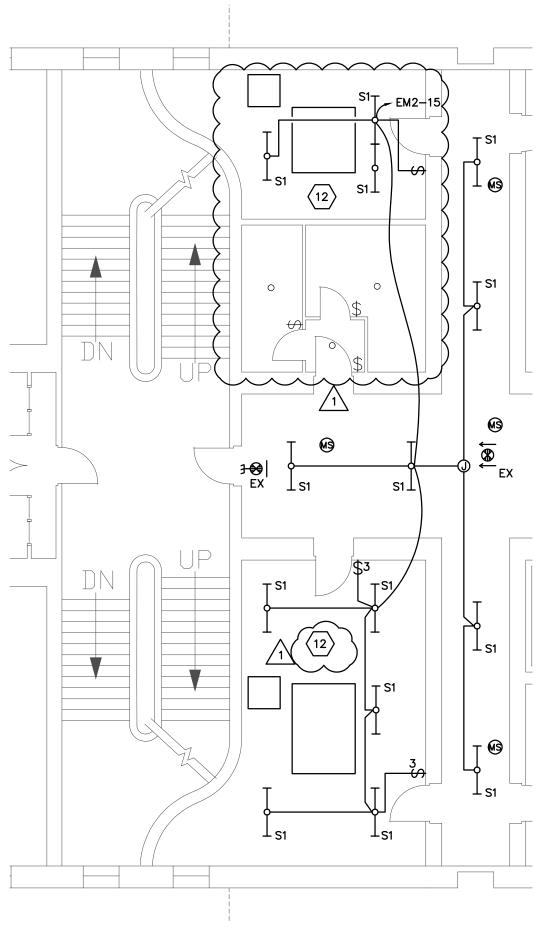

PARTIAL THIRD FLOOR LIGHTING PLAN — NEW WORK scale: 1/8"=1'-0"

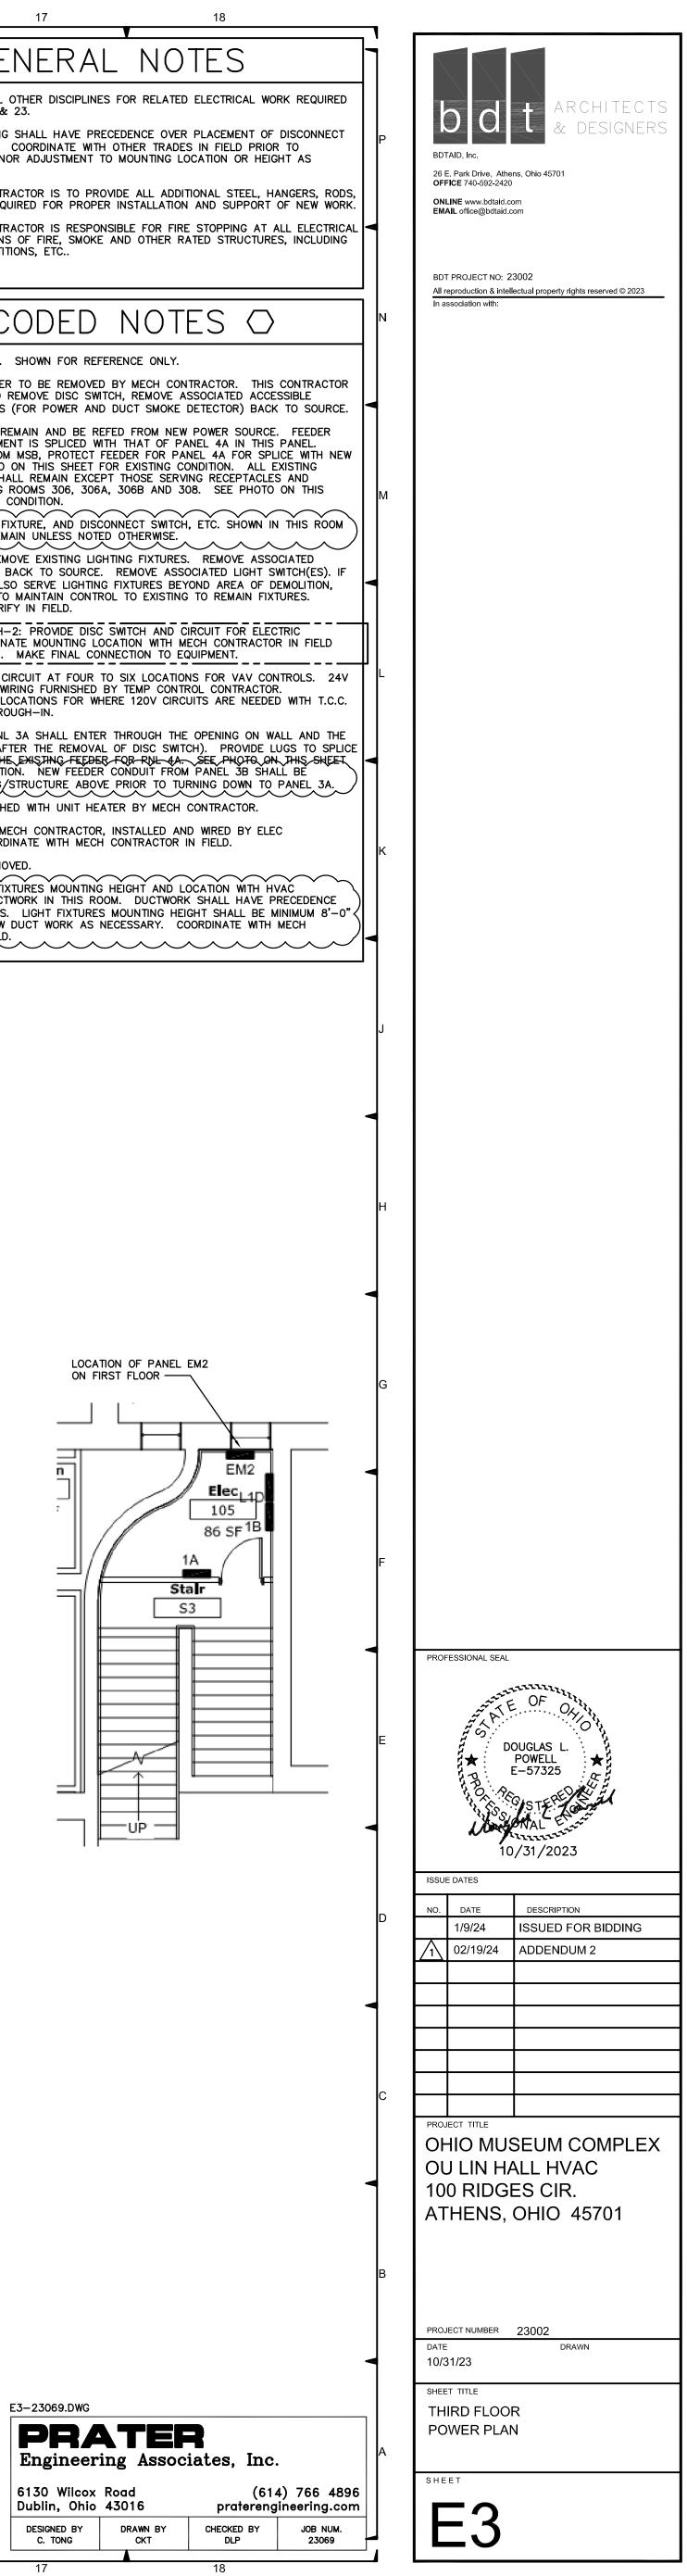


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<b>PRATER</b> Engineering Associates, Inc.					
	6130 Wilcox Dublin, Ohio		(614 pratereng	4) 766 ineering	
	DESIGNED BY C. TONG	DRAWN BY CKT	CHECKED BY DLP	JOB N 2306	
	17		18		




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۷	V		V V		GENERAL	NOTES
				Α.	COORDINATE WITH ALL OTHER DISCIPLINES UNDER DIVISIONS 22 & 23.	FOR RELATED ELECTRICAL WORK REQUIR
				В.	EQUIPMENT AND PIPING SHALL HAVE PREC SWITCH AND/OR VFD. COORDINATE WITH ROUGH-IN. MAKE MINOR ADJUSTMENT TO REQUIRED.	OTHER TRADES IN FIELD PRIOR TO
				C.	THE ELECTRICAL CONTRACTOR IS TO PROV CLAMPS, ETC., AS REQUIRED FOR PROPER	VIDE ALL ADDITIONAL STEEL, HANGERS, R INSTALLATION AND SUPPORT OF NEW W
				D.	THE ELECTRICAL CONTRACTOR IS RESPONS RELATED PENETRATIONS OF FIRE, SMOKE FLOORS, WALLS, PARTITIONS, ETC	SIBLE FOR FIRE STOPPING AT ALL ELECT AND OTHER RATED STRUCTURES, INCLUDI
					CODED	NOTES $\bigcirc$
				1.	EXISTING TO REMAIN. SHOWN FOR REFE	RENCE ONLY.
				2.	TO DISCONNECT AND REMOVE DISC SWIT	BY MECH CONTRACTOR. THIS CONTRACT CH, REMOVE ASSOCIATED ACCESSIBLE DUCT SMOKE DETECTOR) BACK TO SOUR
				∧ 3.	EXISTING PANEL TO REMAIN. SEE SHEE	TS E5 AND E6 FOR MORE INFO.
			2	4.	ALL DEVICES, LIGHT FIXTURE, AND DISCO ARE EXISTING TO REMAIN UNLESS NOTED	DNNECT SWITCH, ETC. SHOWN IN THIS ROOD OTHERWISE.
				5.	DISCONNECT AND REMOVE EXISTING LIGH CONDUIT AND WIRES BACK TO SOURCE.	ITING FIXTURES. REMOVE ASSOCIATED
			<u>ALTH2 NOTES</u> -	6.	UNDER ALTERNATE H-2: PROVIDE DISC HUMIDIFIER. COORDINATE MOUNTING LOC PRIOR TO ROUGH-IN. MAKE FINAL CON	CATION WITH MECH CONTRACTOR IN FIELD
				7.	TRANSFORMER AND WIRING FURNISHED B	
				8.	DISC SWITCH FURNISHED WITH UNIT HEA	TER BY MECH CONTRACTOR.
				9.	VFD FURNISHED BY MECH CONTRACTOR, CONTRACTOR. MAKE FINAL CONNECTION CONTRACTOR IN FIELD.	
			2			DM. DUCTWORK SHALL HAVE PRECEDENCE MOUNTING HEIGHT SHALL BE MINIMUM 8'
				L		

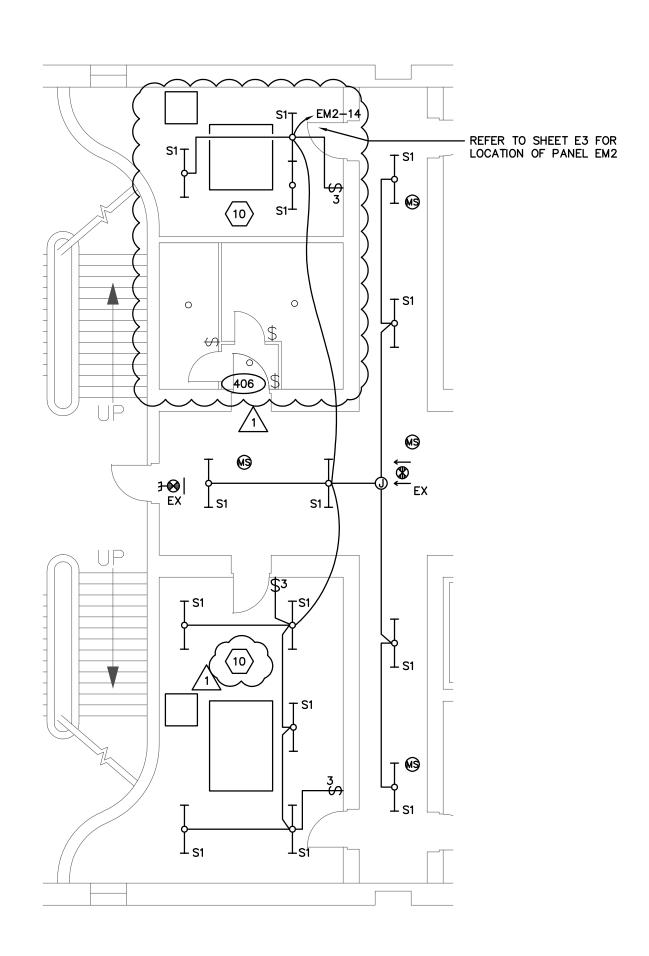

PARTIAL FOURTH FLOOR LIGHTING PLAN – NEW WORK scale: 1/8"=1'-0"

E4-23069.DWG			
	ing Assoc	<b>a</b> tes, Inc.	
6130 Wilcox Dublin, Ohio		614) pratereng	4) 766 ineering
DESIGNED BY C. TONG	DRAWN BY CKT	CHECKED BY DLP	JOB N 230
17		18	

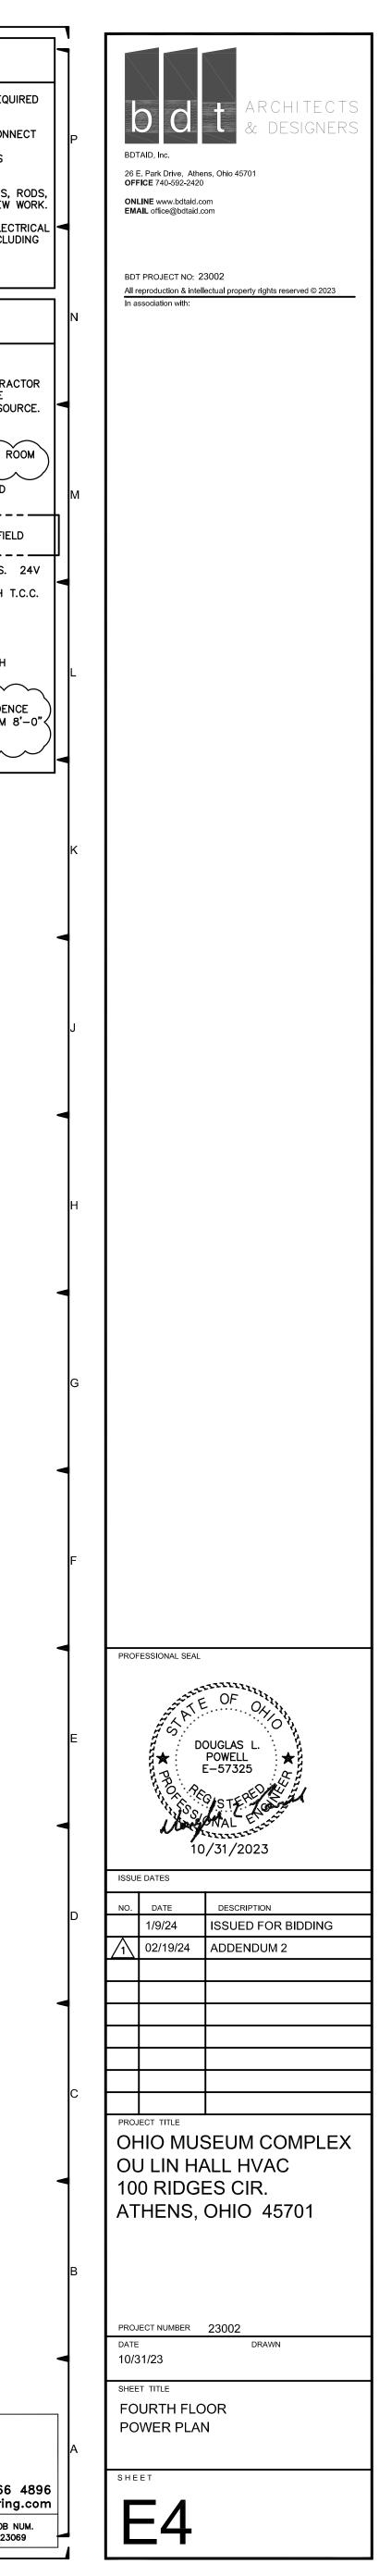


1 2 3 4 5 6	6 7 8 9 10 11 12
KEY: COMBCOMBINATION MAGNETIC ACROSS THE LINE; MANMANUAL; MAGMAGNETIC ACROSS THE LINE; S.DSTAR DELTA; A.TAUTO TRANSFORMER; C.TCONTROL TRANSFORMER; H.O.AHAND/OFF/AUTO SLECTOR SWITCH; PPILOT LIGHT; S.SSTART/STOP PUSHBUTTONS; ON-OFF-ON/OFF MAINTAINED CONTACT SELECTOR SWITCH; H.A HAND AUTO. SELECTOR SWITCH.	LIGHTING FIXTURE SCHEDULE NOTE : FIXTURE NUMBER, LETTER PREFIX INDICATES TYPE OF MOUNTING AS FOLLOWS: CL-CEILING MOUNTED; S-STEM SUSPENDED; W-WALL MOUNTED; R-CEILING RECESSED; WR-WALL RECESSED; CV-COVE MOUNTED; UC-UNDER CABINET; RF-ROOF MOUNTED; SL-SITE LIGHT; GR-GROUND; CH-CHAIN SUSPENDED; P-PENDANT
EQUIPMENT MOTOR POWER TYPE NEMA SIZE N.O. N.C. DEVICES IN COVER C.T. MOUNTING LOCATION REMARKS	FIXTURE NUMBER     DESCRIPTION     MANUFACTURER     CATALOG NUMBER     LAMPS     REMARKS     AFF       AFG
RAF-5A, 5B, RAF-6A, 6B     2.0     208     3     COMB     0     2     2     H.O.A PILOT LIGHT     YES     WALL MOUNT COORDINATE IN FIELD     -	S1       4' LED STRIPLIGHT SEMI FROST LENSE       COOPER DAYBRITE LSI       4SNLED-LD5-53SL-LN-UNV-L840-CD       41W LED 5300 LUMENS 4000K       CHAIN HUNG MOUNT AT 10' A.F.F. COORDINATE WITH HVAC DUCTWORK       BFG         CLG       CLG       CLG       CLG       CLG
	EX       LED EXIT UNIVERSAL MOUNTED RED LETTERING AC ONLY       SURE-LITES CHLORIDE DAYBRITE       LPX6       1.2W LED       PENDANT MOUNT AT 9' A.F.F. WALL MOUNT AT 1'-0' ABOVE DOOR       C         EX       AC ONLY       DAYBRITE       LPX6       1.2W LED       PENDANT MOUNT AT 9' A.F.F. WALL MOUNT AT 1'-0' ABOVE DOOR       CONN
	ADDITIONAL SPECIFICATIONS: EQUIVALENT FIXTURES, BY THE FOLLOWING MANUFACTURERS, MAY BE FURNISHED AT THE CONTRACTOR'S OPTION: HUBBELL LIGHTING, PHILLIPS LIGHTING, ACUITY BRANDS, GE CURRENT, H.E. WILLIAMS, NORA, LITON OR ABB LIGHTING. CONT CONTRACTOR'S OPTION: HUBBELL LIGHTING, DIGHTING, ACUITY BRANDS, GE CURRENT, H.E. WILLIAMS, NORA, LITON OR ABB LIGHTING. DTL DISC
Panel ID: PANEL 3B       Voltage:       208       /       120       Panel Type:          Location: RM 306       Phase:       3       Enclosure:       NEMA-1         Mounting: SURFACE       Wire:       4         Main Type: M.L.O.       Main Size:       225 Amps         NEW PANEL.       PROVIDE 225A FEED THROUGH LUGS FOR PANEL 4A	Panel ID: PANEL 4B       Voltage:       208       / 120       Panel Type:        E.C.       E         Location: RM 406       Phase:       3       Enclosure:       NEMA-1       E       FDR         Mounting: SURFACE       Wire:       4       FDR       FDR       FDR       FDR         NEW PANEL.       FED THROUGH PANEL 3B       FED THROU
** = REFER TO ONE LINE DIAGRAM OR FLOOR PLANS FOR WIRE SIZES         GND WIRE       BRANCH CIRCUIT       OKT       CKT       CONN.       CKT       LOAD       KKT       PLASE       CKT       LOAD       BKR       BKR       LOAD       KKT       PLASE       CKT       LOAD       KKT       PLASE       CKT       LOAD       KKT       BKR       LOAD       KKT       PLASE       CKT       LOAD       KKT       PLASE       CKT       LOAD       KKT       PLASE       CKT       LOAD	** = REFER TO ONE LINE DIAGRAM OR FLOOR PLANS FOR WIRE SIZE         GND       WIRE       BRANCH CIRCUIT       CKT       CKT       CKT       NO.       KKT       PLASE       CKT       CNN       KKT       BKR       BKR       BKR       BKR       BKR       BKR       CNT       CNN       KKT       DESCRIPTION       SIZE       SIZE       DESCRIPTION       SIZE       SIZE       OPTION       SIZE       SIZE       DESCRIPTION       SIZE       SIZE       SIZE       OPTION       SIZE       SIZE       OPTION       SIZE       SIZE       SIZE       OPTION       SIZE       SIZE       OPTION       SIZE       SIZE       SIZE       OPTION       SIZE       SIZE       SIZE       SIZE       SIZE       SIZE       OPTION       SIZE       SIZE       SIZE       SIZE       SIZE       SIZE       OPTION       SIZE
Panel ID: PANEL 2B       Voltage:       208       /       120       Panel Type:          Location: RM 206       Phase:       3       Enclosure:       NEMA-1         Mounting: SURFACE       Wire:       4         Main Type: M.C.B.       Main Size:       200 Amps         EXISTING PANEL. LOADS SHOWN OBTAINED FROM EXISTING ENGINEERING DRAWINGS.         ALL BREAKERS SHWON ARE EXISTING TO REMAIN UNLESS NOTED OTHERWISE.         * = NEW CIRCUIT SERVING EXISTING PANELS. LOADS SHOWN ARE APPROXIMATE.         ** = REFER TO ONE LINE DIAGRAM OR FLOOR PLANS FOR WIRE SIZES         GND       CKT       CKT       CKT       CONN.       CKT       CKT       DESCRIPTION         SIZE       DESCRIPTION       SIZE       OPTION       (KVA)       NO.       NO.       (KVA)       OPTION       SIZE       SIZE       SIZE       SIZE       DESCRIPTION       SIZE       SIZE       SIZE       SIZE       SIZE       SIZE       SIZE       DESCRIPTION       SIZE       SIZE	Panel ID: PANEL B6Voltage:208 / 120Panel Type:Location: RM 018APhase:3Enclosure:NEMA-1Main Type: M.C.B.Main Size:200 AmpsEXISTING PANEL.ALL BREAKERS SHWON ARE EXISTING TO REMAIN UNLESS NOTED OTHERWISE.* = REFER TO ONE LINE DIAGRAM OR FLOOR PLANS FOR WIRE SIZES*** = REFER TO ONE LINE DIAGRAM OR FLOOR PLANS FOR WIRE SUDERSIZE SIZEOPSOLID RAW CIRCUITBKRCKTCKTCKTCKTCONN.CKTCKTCONN.CKTCONN.CKTCANCKTCONN.CKTLOADBRANCH CIRCUITBKRBRANCH CIRCUITBKRDESCRIPTIONSIZEDESCRIPTIONSIZEDESCRIPTIONSIZEDESCRIPTIONSIZEDESCRIPTIONSIZEDESCRIPTIONSIZEDESCRIPTION </th
EX       EX       LX       1.300       11       C       12       1.20       EX       20/1       EX       EX       EX       20/1       EX       EX       1.100       EX       1.200       EX       EX       20/1       REC 20002       EX       EX       EX       EX       20/1       REC 20002       EX       EX       EX       20/1       PROJECTOR       EX       EX       EX       EX       EX       LTG 201, 203       20/1       EX       1.336       15       B       16       0.500       EX       20/1       PROJECTOR       EX       EX         EX       EX       LTG 201, 203       20/1       EX       1.500       17       C       18       1.421       EX       20/1       LTG CLASSRM, EXT/EGR       EX       EX       EX       EX       EX       1.1500       17       C       18       1.421       EX       20/1       LTG CLASSRM, EXT/EGR       EX	EX       MACHINE       -       EX       0.000       13       A       14       0.000       EX       -       -       0.000       13       A       14       0.000       EX       20/1       CAFÉ COLER       EX       EX       EX       EX       EX       COFFEE BREWER       20/2       EX       0.000       EX       20/1       AHU-1 HUMIDIFIER       EX


1 2 3 4 5 6	6 7 8 9 10 11	12				
KEY: COMBCOMBINATION MAGNETIC ACROSS THE LINE; MANMANUAL; MAGMAGNETIC ACROSS THE LINE; S.DSTAR DELTA; A.TAUTO TRANSFORMER; C.TCONTROL TRANSFORMER; H.O.AHAND/OFF/AUTO SLECTOR SWITCH; PPILOT LIGHT; S.SSTART/STOP PUSHBUTTONS; ON-OFF-ON/OFF MAINTAINED CONTACT SELECTOR SWITCH; H.A HAND AUTO. SELECTOR SWITCH.	LIGHTING FIXTURE SCHEDULE NOTE : FIXTURE NUMBER, LETTER PREFIX INDICATES TYPE OF MOUNTING AS FOLLOWS: CL-CEILING MOUNTED; S-STEM SUSPENDED; W-WALL MOUNTED; R-CEILING RECESSED; WR-WALL RECESSED; CV-COVE MOUNTED; UC-UNDER CABINET; RF-ROOF MOUNTED; SL-SITE LIGHT; GR-GROUND; CH-CHAIN SUSPENDED; P-PENDANT					
EQUIPMENT MOTOR POWER TYPE NEMA AUX. CONT. DEVICES 120 V MOUNTING LOCATION REMARKS	FIXTURE DESCRIPTION MANUFACTURER CATALOG NUMBER LAMPS REMARKS	A				
ITEM     HP     VOLT     PHASE     SIZE     N.O.     N.C.     IN COVER     C.T.       RAF-5A, 5B, RAF-6A, 6B     2.0     208     3     COMB     0     2     2     H.O.A PILOT LIGHT     YES     WALL MOUNT COORDINATE IN FIELD     -	A' LED STRIPLIGHT SEMI FROST LENSE COOPER DAYBRITE ASNLED-LD5-53SL-LN-UNV-L840-CD 5300 LUMENS LSI LSI 4000K					
	EX LED EXIT UNIVERSAL MOUNTED SURE-LITES LPX6 1.2W LED PENDANT MOUNT AT 9' A.F.F RED LETTERING CHLORIDE DAYBRITE LPX6 1.2W LED PENDANT MOUNT AT 9' A.F.F	.F.F. C				
	ADDITIONAL SPECIFICATIONS: EQUIVALENT FIXTURES, BY THE FOLLOWING MANUFACTURERS, MAY BE FURNISHED AT THE CONTRACTOR'S OPTION: HUBBELL LIGH PHILLIPS LIGHTING, ACUITY BRANDS, GE CURRENT, H.E. WILLIAMS, NORA, LITON OR ABB LIGHTING.	GHTING, C C D				
Panel ID: PANEL 3B       Voltage:       208 / 120       Panel Type:         Location: RM 306       Phase:       3       Enclosure:       NEMA-1         Mounting: SURFACE       Wire:       4         Main Type: M.L.O.       Main Size:       225 Amps         NEW PANEL.       PROVIDE 225A FEED THROUGH LUGS FOR PANEL 4A	Panel ID: PANEL 4B       Voltage:       208       / 120       Panel Type:          Location: RM 406       Phase:       3       Enclosure:       NEMA-1         Mounting: SURFACE       Wire:       4         Main Type: M.L.O.       Main Size:       225 Amps         NEW PANEL.       FED THROUGH PANEL 3B	D E Fi				
** = REFER TO ONE LINE DIAGRAM OR FLOOR PLANS FOR UNE SUZE         GND WIRE       BRANCH CIRCUIT       KR       KR       LOAD       KT       PHASE       CN       CONN.       CKT       CKT       CAN       BRANCH CIRCUIT       WIRE GND         12       12       AHU-5A       20/3       -       1.920       1       A       2       1.920       -       2/0/3       AHU-5B       1/2       1/2         12       -       -       -       1.920       1       A       2       1.920       -       -       1/2       1/2       -       -       1/2       1/2       -       -       1/2       1/2       -       -       1/2       1/2       -       -       1/2       1/2       -       -       1/2       1/2       -       -       1/2       1/2       -       -       1/2       1/2       <t< td=""><td>SIZE         SIZE         DESCRIPTION         SIZE         OPTION         (KVA)         NO.         (KVA)         OPTION         SIZE         DESCRIPTION         SIZE         SIZE           12         12         AHU-6A         20/3          1.920         1         A         2         1.920          20/3         AHU-6B         12         12           -         12         -         -         -         1.920         3         B         4         1.920          -         -         12         -         -         12         -         -         12         -         -         12         -         -         12         -         -         12         -         -         12         -         -         12         -         -         12         -         -         12         -         -         12         -         -         12         -         -         12         -         -         12         -         -         -         12         -         -         -         12         -         -         12         -         -         -         12         -         -         -</td><td></td></t<>	SIZE         SIZE         DESCRIPTION         SIZE         OPTION         (KVA)         NO.         (KVA)         OPTION         SIZE         DESCRIPTION         SIZE         SIZE           12         12         AHU-6A         20/3          1.920         1         A         2         1.920          20/3         AHU-6B         12         12           -         12         -         -         -         1.920         3         B         4         1.920          -         -         12         -         -         12         -         -         12         -         -         12         -         -         12         -         -         12         -         -         12         -         -         12         -         -         12         -         -         12         -         -         12         -         -         12         -         -         12         -         -         12         -         -         -         12         -         -         -         12         -         -         12         -         -         -         12         -         -         -					
Panel ID: PANEL 2B       Voltage:       208       /       120       Panel Type:          Location: RM 206       Phase:       3       Enclosure:       NEMA-1         Mounting: SURFACE       Wire:       4         Main Type: M.C.B.       Main Size:       200 Amps         EXISTING PANEL. LOADS SHOWN OBTAINED FROM EXISTING ENGINEERING DRAWINGS.       ALL BREAKERS SHWON ARE EXISTING TO REMAIN UNLESS NOTED OTHERWISE.         * = NEW CIRCUIT SERVING EXISTING PANELS. LOADS SHOWN ARE APPROXIMATE.       ** = REFER TO ONE LINE DIAGRAM OR FLOOR PLANS FOR WIRE SIZES         CND WIRE       BRANCH CIRCUIT       KR       LOAD       CONN.       CKT       CKT       WIRE CND	Panel ID: PANEL B6 Voltage: 208 / 120 Panel Type: Location: RM 018A Phase: 3 Enclosure: NEMA-1 Mounting: SURFACE Wire: 4 Main Type: M.C.B. Main Size: 200 Amps EXISTING PANEL. ALL BREAKERS SHWON ARE EXISTING TO REMAIN UNLESS NOTED OTHERWISE. * = NEW CIRCUIT ** = REFER TO ONE LINE DIAGRAM OR FLOOR PLANS FOR WIRE SIZES *** = PROVIDE NEW CIRCUIT BREAKER, CONDUIT AND WIRES UNDER ALTH1 GND WIRE BRANCH CIRCUIT BKR BKR LOAD CKT PHASE CKT LOAD BKR BKR BRANCH CIRCUIT WIRE GND					
GND <wire SIZE         BRANCH CIRCUIT         SIZE SIZE         OPTION DESCRIPTION         SIZE SIZE         OPTION (KVA)         ONO         NO.         NO.         (KVA)         OPTION         SIZE SIZE         BRANCH CIRCUIT DESCRIPTION         SIZE SIZE         SIZE SIZE         DESCRIPTION         SIZE SIZE         SIZE SIZE         SIZE DESCRIPTION         SIZE SIZE         SIZE SIZE         DESCRIPTION         SIZE SIZE         SIZE SIZE         DESCRIPTION         SIZE SIZE         SIZE SIZE         SIZE SIZE         DESCRIPTION         SIZE SIZE         SIZE SIZE         SIZE SIZE         SIZE SIZE         CAT         CAT         A         Z         SIZE         SIZE SIZE         AHU-4A         EX         SIZE SIZE         CITE CODAD         CITE CODAD         SIZE         SIZE SIZE         CITE CODAD         SIZE SIZE         SIZE SIZE         TECODAD</wire 	Size       Size       DESCRIPTION       Size       OPTION       (KVA)       NO.       (KVA)       OPTION       Size       DESCRIPTION       Size       Size	<u>ALT.—H1</u>				
Phase C:       12.2 KVA       101.9 AMPS       GF - GND Fault CKT Interrupter         Total:       32.9 KVA       EX - Existing to Remain         SH - Shunt Trip Breaker	Phase C:       0.4 KVA       3.0 AMPS       GF - GND Fault CKT Interrupter         NEW LAOD ADDED TO PANEL:       Total:       1.2 KVA       EX - Existing to Remain         SH - Shunt Trip Breaker       SH - Shunt Trip Breaker					

		Panel ID				ltage:			120	Panel T				
		Location			F	hase:				Enclosu	re:	NEMA-1		
		Mounting				Wire:								
		Main Type				Size:		Amps						
		NG PANEL. LOADS SHOWN												
		REAKERS SHWON ARE EX												
	" = NE	W CIRCUIT SERVING EXIST	ING PA	NELS. LU										
	** - PI	EFER TO ONE LINE DIAGRA					91759							
					CONN.				CONN.	СКТ	СКТ	1		Т
	WIRE	BRANCH CIRCUIT	BKR	BKR	LOAD	Скт	PHASE	Скт	LOAD	BKR	BKR	BRANCH CIRCUIT	WIRE	= G
	SIZE	DESCRIPTION				NO.		NO.	(KVA)	OPTION		DESCRIPTION	SIZE	
EX	EX		20/3	EX	1.321	1	A	2	1.321	EX	20/3	AHU-4A	EX	_
_	EX		-		1.321	3	B	4	1.321		-	_	EX	
-	EX	-	-		1.321	5	С	6	1.321		_	-	EX	1
ΕX	EX	TEL BOARD	20/1	EX	0.360	7	A	8	0.720	EX	20/1	REC 202A	EX	E
ΕX	EX	REC 20003	20/1	EX	0.900	9	В	10	0.900	EX	20/1	REC 202	EX	E
ΕX	EX	REC 2004	20/1	EX	0.900	11	С	12	0.720	EX	20/1	REC 20002	EX	E
ΕX	EX	LTG 200034, EX / EGR	20/1	EX	1.280	13	A	14	0.540	EX	20/1	REC 20002	EX	E
ΕX	EX	LTG 210	20/1	EX	1.336	15	В	16	0.500	EX	20/1	PROJECTOR	EX	E
ΕX	EX	LTG 201, 203	20/1	EX	1.500	17	C	18	1.421	EX	20/1	LTG CLASSRM, EXT/EGR	EX	E
ΕX	EX	HONEYWELL PANEL	20/1	EX	0.500	19	A	20	1.500	EX	20/1	LTG 204	EX	E
ΕX	EX	LTG 20002	20/1	EX	1.500	21	В	22	0.574	EX	20/1	LTG 202A	EX	E
ΕX	EX	LTG 20002	20/1	EX	1.500	23	C	24	1.000	LO, EX	20/1	DOOR HOL, F/SMK DAMPER	EX	E
ΕX	EX	PROJECTOR	20/1	EX	1.000	25	A	26	0.000		20/1			
-	-	EXLOAD	20/2	EX	0.000	27	В	28	0.300	EX	20/1	* VAV CONTROLS	12	•
-	-	-	-		0.000	29	C	30	1.540	NEW	30/3	* EXISTING	**	1
-	-	EXLOAD	20/1	EX	0.000	31	A	32	1.540		-	PANEL 3A, 4A	**	
ΕX	EX	DOOR CONTROL	20/1	EX	0.360	33	В	34	1.540		-	-	**	
-	-	EXLOAD	20/1	EX	0.000	35	C	36	0.000		20/1	SPARE	-	
-	-	EXLOAD	20/1	EX	0.000	37	A	38	0.000		20/1	COND PUMP	-	
-	-	EXLOAD	20/1	EX	0.000	39	В	40	0.000		20/1	SPARE	-	
-	-	EXLOAD	20/1	EX	0.000	41	C	42	1.000		25/1	DEHUMIDIFIER	EX	E
					Conne	ected I	_oad Par		-			ker Options (If Used):		
						ase A:		KVA				andle Tie		
						ase B:		KVA	87.9	AMPS	LO - L	ock-On Device		
					Ph	ase C:		KVA	101.9	AMPS		ND Fault CKT Interrupter		
						Total	32.9	KVΔ			FX - F	visting to Remain		

		Panel I	D: PANEL	EM2	Vo	ltage:	208	1	120	Panel T	ype:			
		Locatio	n: RM 105	5	Р	hase:	3			Enclosu	re:	NEMA-1		
		Mountin	g: SURFA	CE		Wire:	4							
		Main Typ	e: M.L.O.		Main	Size:	60	Amp	6					
	EXISTI	NG PANEL TO REMAIN.												
	ALL BF	REAKERS SHOWN ARE EX	<b>(ISTING U</b>	INLESS N	OTED OTH	HERW	ISE.							
	* = NE\	V LOAD, EXISTING BREA	KER											
				1			I			1	-	1		
			CKT	СКТ	CONN.				CONN.	СКТ	СКТ			
	WIRE	BRANCH CIRCUIT	BKR	BKR	LOAD	СКТ	PHASE		LOAD	BKR	BKR	BRANCH CIRCUIT	WIRE	
	SIZE	DESCRIPTION		OPTION	(KVA)	NO.		NO.	(KVA)	OPTION		DESCRIPTION	SIZE	
EX	EX	EXLOAD	20/1	EX	0.000	1	Α	2	0.000	EX	20/1	EXLOAD	EX	E
ΕX	EX	EX LOAD	20/1	EX	0.000	3	В	4	0.000	EX	20/1	EX LOAD	EX	E
ΕX	EX	EX LOAD	20/1	EX	0.000	5	С	6	0.000	EX	20/1	EX LOAD	EX	E
ΕX	EX	EX LOAD	20/1	EX	0.000	7	Α	8	0.000	EX	20/1	EXLOAD	EX	E
ΕX	EX	EX LOAD	20/1	EX	0.000	9	В	10	0.000	EX	20/1	EXLOAD	EX	E
ΕX	EX	EX LOAD	20/1	EX	0.000	11	С	12	0.660	EX	20/1	* EXIT, LIGHT - 3RD FLOOR	12	1
ΕX	EX	EX LOAD	20/1	EX	0.000	13	Α	14	0.660	EX	20/1	* EXIT, LIGHT - 4TH FLOOR	12	1
-	-	SPACE	-		0.000	15	В	16	0.000	EX	20/1	SPARE	-	
-	-	SPACE	-		0.000	17	С	18	0.000	EX	20/1	SPARE		
-	-	SPACE	-		0.000	19	Α	20	0.000		20/1	ADA DOOR OPERATOR	EX	E
							oad Par					ker Options (If Used):		
						ase A:		KVA				andle Tie		
					Pha	ase B:	0.0	KVA	0.0	AMPS	LO - L	ock-On Device		
					Pha	ase C:	0.7	KVA	5.5	5 AMPS	GF - G	ND Fault CKT Interrupter		
						Total:	1.3	KVA				kisting to Remain		
											SH - S	hunt Trip Breaker		

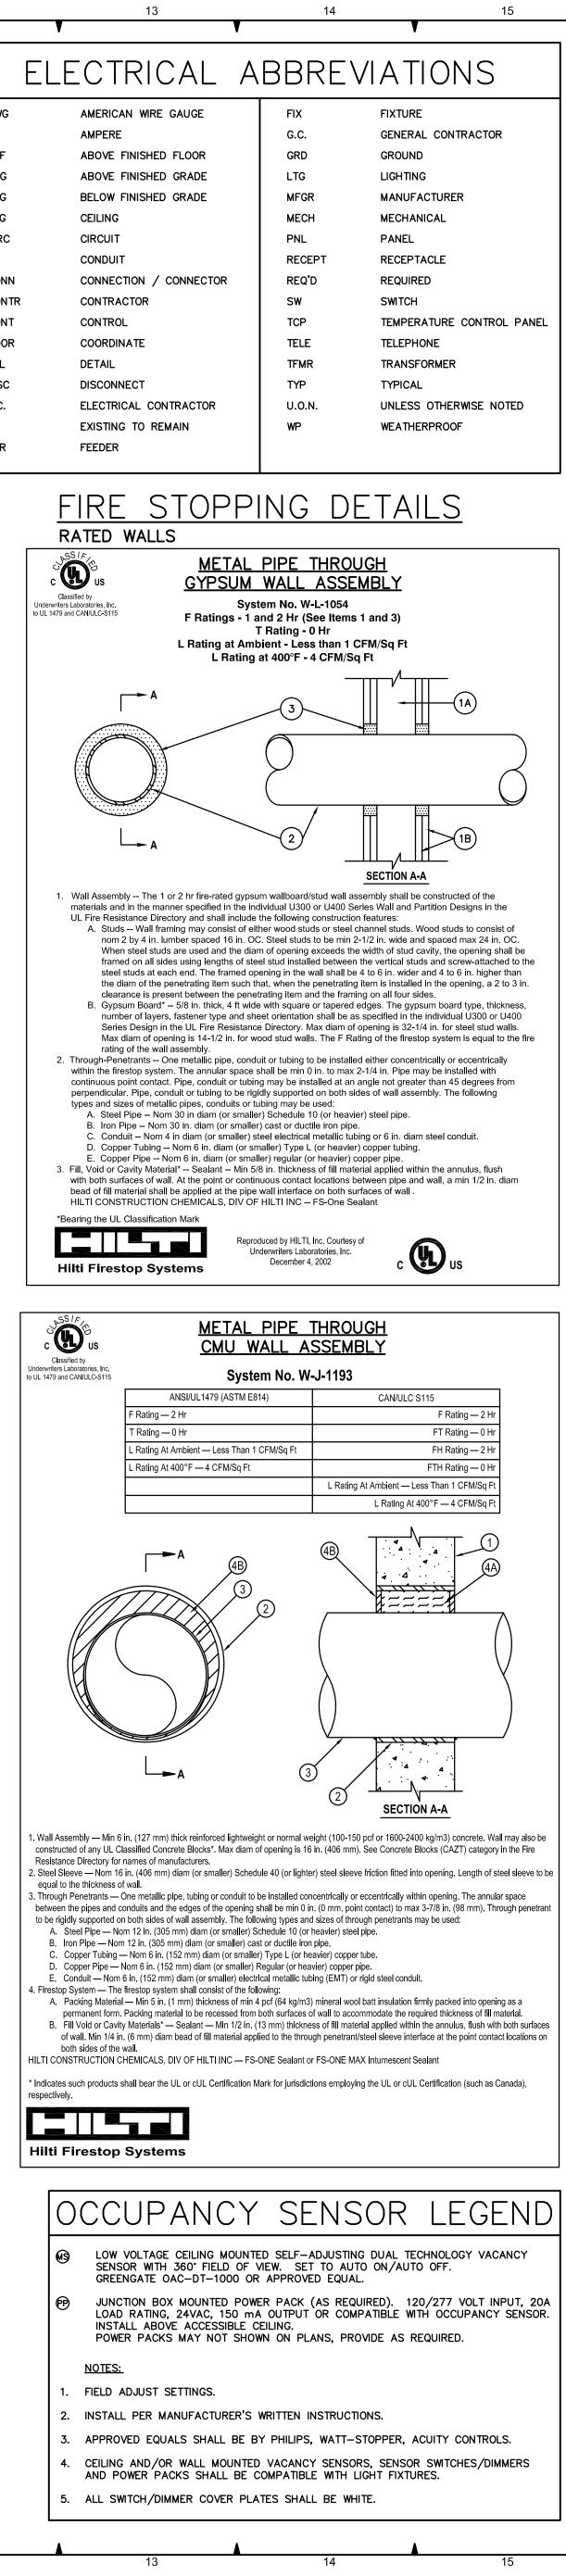

16	17 18	
	ELECTRICAL LEGEND	
SYMBOL		HGT. TO CENTER THERWISE NOTED
	RECESSED OR SUSPENDED LUMINAIRE/LIGHT FIXTURE	SEE DRAWING
	J REFER TO THE LIGHTING FIXTURE SCHEDULE	
	POLE MTD. LIGHT FIXTURE	SEE DRAWING
Ĵ-O€	WALL MTD. LGHT FIXTURE	SEE DRAWING
₩	WALL MTD. EXIT LIGHT	AB DOOR
€ <u>®</u> €	CEILING MOUNTED EXIT LIGHT W/ DIRECTIONAL ARROWS	-
00 00000000000000000000000000000000000	CEILING OR WALL MTD. EXIT-EM LIGHT COMBO UNIT EMERGENCY REMOTE HEADS	CLG / AB DO CLG / AB DO
$\varphi_{-}\varphi$	EMERGENCY BATTERY UNIT	90"
	DUPLEX RECEPTACLE	18"
۲	POWER AND VOICE/DATA POKE THROUGH	FLOOR MTD
±⊖ WP	DUPLEX RECEPTACLE WEATHERPROOF / GROUND FAULT	18 <b>"</b>
I GF	DUPLEX RECEPTACLE W/ GROUND FAULT INTERRUPTER	18 <b>"</b>
€	220V RECEPTACLE	18"
<b>D</b>	DOUBLE DUPLEX RECEPTACLE	18"
۲	20A POWER ONLY FLOOR BOX	FLOOR
() () _F	JUNCTION BOX; WALL / CEILING MOUNTED: FLOOR MOUNTED	SEE DRAWING
PB	PULL BOX	SEE DRAWING
\$ \$3 \$4	TOGGLE SWITCH - SINGLE, 3-WAY & 4-WAY	42"
\$к\$wp	TOGGLE SWITCH $- K = OPERATED, WP = WEATHERPROOF$	42"
ば ば ₂	WALL BOX FOR "VOICE/DATA" OUTLET, 1-PORT, 2-PORT WITH 1"C. TO ABOVE CEILING OR TO 8' A.F.F WHEN CONDUIT IS SURFACE MOUNTED, UNLESS A LARGER CONDUIT IS INDICATED	18"
⋈ [₩]	WALL TELEPHONE OUTLET	48"
${}$	WRELESS ACCESS POINT	
(J) (J)	MOTOR – 1 PHASE MOTOR – 3 PHASE	AS REQUIRE
0 D	MOTORIZED DAMPER - 1 PHASE	AS REQUIRE
	ELECTRICAL PANEL - SURFACE MOUNT, FLUSH MOUNT	6'-0" TO TO
	PLYWOOD TELEPHONE BACKBOARD	SEE DRAWING
	SAFETY SWITCH	AS REQUIRE
$\boxtimes$	MAGNETIC MOTOR STARTER	AS REQUIRE
R	COMBINATION MOTOR STARTER	AS REQUIRE
- <b>\</b>	MANUAL MOTOR STARTING SWITCH W/ PILOT LIGHT	42"
+	MANUAL MOTOR CONTROLLER/DISCONNECT	42"
① F	LINE VOLTAGE THERMOSTAT FIRE ALARM MANUAL PULL STATION	60" 42"
E E	FIRE ALARM SIGNAL - AUDIO VISUAL	42 80"
E⊲ _{CLG}	FIRE ALARM SIGNAL - AUDIO VISUAL	CEILING
ED-	FIRE ALARM SIGNAL - STROBE ONLY	80"
<u>∧</u> ×	SMOKE DETECTOR - DUCT MOUNTED	SEE DRAWING
¢	SMOKE DETECTOR - CEILING	
Θ	HEAT DETECTOR - CEILING	
SD	DUCT SMOKE DETECTOR W/ SMOKE DAMPER	SEE DRAWING
Ts E	SPRINKLER SYSTEM TAMPER SWITCH	SEE DRAWING
Fs	SPRINKLER SYSTEM FLOW SWITCH	SEE DRAWING
R	DUCT SMOKE DETECTOR REMOTE TEST SWITCH	SEE DRAWING
BO	FIRE ALARM BELL	SEE DRAWING
P	DRY PIPE LOW AIR PRESSURE SWITCH	SEE DRAWING
	VALVE SUPERVISORY SWITCH	SEE DRAWING
	PUSH BUTTON	SEE DRAWING
—	GROUND BAR	18"
<b>Э-©</b> ⊠гт	FIRE ALARM TELEPHONE JACK	48"
₽®	WRED FURNITURE FEED JUNCTION BOX - WALL	18" U.N.O.
ЮF	FURNITURE FEED VOICE/DATA CONNECTION - WALL	18" U.N.O.
DO	DOOR AUTO OPERATOR PUSH PAD	42"
AO	DOOR HARDWARE AUTO OPERATOR	AB. DOOR
EPT	ELECTRIC POWER TRANSFER	AS REQUIRE
®	ACCESS CONTROL CARD READER	46"
© ©	CONTACT SWITCH ELECTRIC STRIKE/LOCK	TOP DOOR FR
€	ELECTRIC STRIKE/LOCK	AS REQUIRE
<b>(</b>	MAGNETIC LOCK	AS REQUIRE
ල	DOOR HARDWARE POWER SUPPLY	AS REQUIRE
⊕	PANIC HARDWARE	AS REQUIRE
60	ACCESS CONTROL SAFE CONTACT SWITCH	AT EQUIPMEN
	FLUSH WALL BOX FOR "CCTV" UNLESS NOTED OTHERWISE (WITH 3/4" C. TO HEADEND EQUIPMENT)	SEE DRAWING
Μ	POWER METER	SEE DRAWING

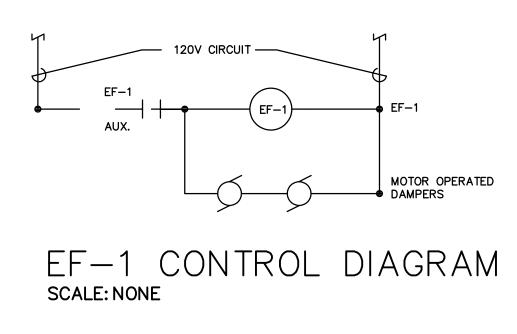

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17		18					

